
M CON PRECAST PLANT PHASE 2 & PHASE 4 EXPANSION 2460 CARP ROAD OTTAWA, ONTARIO



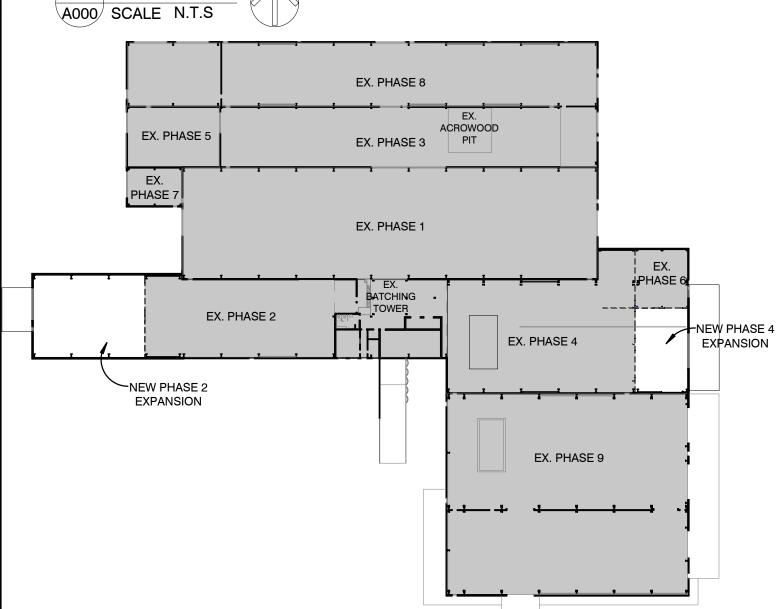

<u>LIST</u>	OF CONTRACT DOCUMENTS:
ARCHITI	ECTURAL:
4000 4001	LOCATION PLAN, LIST OF CONTRACT DOCUMENTS, SPECIFICATIONS, OBC (2012) MATRIX
	PHASE 2 & 4 DEMOLITION PLANS PHASE 2 & 4 DEMOLITION ELEVATIONS
4100	SITE PLAN
4101	OVERALL PLANT FLOOR PLAN & EXITING PATHS
4102	PHASE 2 EXPANSION FLOOR PLAN, PLAN DETAILS
4103	PHASE 4 EXPANSION FLOOR PLAN, PLAN DETAILS
4104	PHASE 2 & 4 ROOF PLAN, D/F/H SCHEDULE
4200	PHASE 2 ELEVATIONS
A201	PHASE 4 ELEVATIONS PHASE 2 BUILDING SECTIONS
43 <i>0</i> 1	PHASE 4 BUILDING SECTIONS PHASE 4 BUILDING SECTIONS
4350	PHASE 2 WALL SECTIONS
4351	PHASE 2 WALL SECTIONS
4352	PHASE 4 WALL SECTIONS
STRUCT	TIRAI:
5000	
	GENERAL NOTES
5201	NEW PHASE 2 FOUNDATION PLAN
5201 5202	NEW PHASE 2 FOUNDATION PLAN NEW PHASE 2 STEEL
5201 5202 5203	NEW PHASE 2 FOUNDATION PLAN NEW PHASE 2 STEEL NEW PHASE 2 STEEL
5201 5202 5203 5204	NEW PHASE 2 FOUNDATION PLAN NEW PHASE 2 STEEL NEW PHASE 2 STEEL NEW PHASE 2 STEEL NEW PHASE 2 ELEVATION OF NEW STEEL
5201 5202 5203 5204 5205	NEW PHASE 2 FOUNDATION PLAN NEW PHASE 2 STEEL NEW PHASE 2 STEEL
5201 5202 5203 5204 5205 5206 5401	NEW PHASE 2 FOUNDATION PLAN NEW PHASE 2 STEEL NEW PHASE 2 STEEL NEW PHASE 2 ELEVATION OF NEW STEEL NEW PHASE 4 FOUNDATION PLAN
5201 5202 5203 5204 5205 5206 5401	NEW PHASE 2 FOUNDATION PLAN NEW PHASE 2 STEEL NEW PHASE 2 STEEL NEW PHASE 2 ELEVATION OF NEW STEEL NEW PHASE 4 FOUNDATION PLAN NEW PHASE 4 FOUNDATION DETAILS, SECTIONS
5201 5202 5203 5204 5205 5206 5401 5402	NEW PHASE 2 FOUNDATION PLAN NEW PHASE 2 STEEL NEW PHASE 2 STEEL NEW PHASE 2 ELEVATION OF NEW STEEL NEW PHASE 4 FOUNDATION PLAN NEW PHASE 4 FOUNDATION DETAILS, SECTIONS NEW PHASE 4 STEEL
5201 5202 5203 5204 5205 5206 5401 5402 5403	NEW PHASE 2 FOUNDATION PLAN NEW PHASE 2 STEEL NEW PHASE 2 STEEL NEW PHASE 2 ELEVATION OF NEW STEEL NEW PHASE 2 ELEVATION OF NEW STEEL NEW PHASE 2 ELEVATION OF NEW STEEL NEW PHASE 4 FOUNDATION PLAN NEW PHASE 4 FOUNDATION DETAILS, SECTIONS NEW PHASE 4 STEEL NEW PHASE 4 STEEL
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5201 5202 5203 5204 5205 5206 5401 5402 5403 5404 5405 5406 MECHA	NEW PHASE 2 FOUNDATION PLAN NEW PHASE 2 STEEL NEW PHASE 2 STEEL NEW PHASE 2 ELEVATION OF NEW STEEL NEW PHASE 2 ELEVATION OF NEW STEEL NEW PHASE 2 ELEVATION OF NEW STEEL NEW PHASE 4 FOUNDATION PLAN NEW PHASE 4 FOUNDATION DETAILS, SECTIONS NEW PHASE 4 STEEL NEW PHASE 4 STEEL NEW PHASE 4 STEEL NEW PHASE 4 ELEVATION OF NEW STEEL
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5201 5202 5203 5204 5205 5206 5401 5402 5403 5405 5406 MECHA M-1 M-2 M-3 M-4	NEW PHASE 2 FOUNDATION PLAN NEW PHASE 2 STEEL NEW PHASE 2 STEEL NEW PHASE 2 ELEVATION OF NEW STEEL NEW PHASE 2 ELEVATION OF NEW STEEL NEW PHASE 2 ELEVATION OF NEW STEEL NEW PHASE 4 FOUNDATION PLAN NEW PHASE 4 FOUNDATION DETAILS, SECTIONS NEW PHASE 4 STEEL NEW PHASE 4 STEEL NEW PHASE 4 STEEL NEW PHASE 4 ELEVATION OF NEW STEEL
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tem				latrix Parts 3 & 9		eference
	Project Descrip	tion:	☐ New	☐ Part 11	■ Part 3	☐ Part 9
1			Addition	11.1 to 11.4	1.1.2	1.1.2
		☐ Change of Use	☐ Alteration			9.10.1.3
	One storey add	lition to an existing one-	storey precast o	orete plant.		
2	Major Occupan	cie(s)	F3 (Low haza	ard for combustible content	3.1.2.1.(1)	9.10.2
			Existing	8,56	_	
3	Building Area (ı	m²)	New		1 1.1.3.2	1.1.3.2
			Total	9,14		
			Existing	8,69		4.4.0.0
4	Gross Area (m²	f)	New		1 1.1.3.2	1.1.3.2
			Total Above Grade	9,27	/ 1	
5	Number of Stor	reys	Below Grade		3.2.1.1	9.10.4
6	Number of Stre	ets/Fire Fighter Access	Below Glade		1 3.2.2.10 & 3.2.5.	9.10.20.3
	Building Classif				2 3.2.2.2083	9.10.2
·	Landing Gracesi		antire buildir		3.2.2.2083	9.10.8.2
			basement o	•	3.2.1.5	9.10.0.2
8	Sprinkler Syste	m Proposed		•	3.2.2.17	
			in lieu of roo	•	3.2.2.17	
			not required			
9	Standpipe requ	ired	☐ Yes	■ No	3.2.9	N/A
			(Existing	Alternative Solution)		
10	Fire Alarm Req	uired	☐ Yes	■ No	3.2.4	9.10.18.2
11	Adequate Wate		■ Voc	□ No.	3 2 5 7	N/A
11	Firefighting Pro		■ Yes	□ No	3.2.5.7	N/A
12	High Building		☐ Yes	■ No	3.2.6	N/A
	Permitted	☐ Combustible	Both			
	Construction	■ Non-combustible				
13	Actual	☐ Combustible	Both		3.2.2.20-83	9.10.6
	Construction	■ Non-combustible	_ Doi:			
1.1		<u> </u>		40	0 0 0 1 1 (0) (0)	9.10.4.1
	Mezzanine(s) A		D **		3 3.2.1.1.(3)-(8)	
15	Occupant Load		☐ m²/person	design of building	3.1.17	9.9.1.3
16	Barrier-free Des	sign	☐ Yes	■ No (Explain)	3.8	9.5.2/3.8
10	No changes pro	oposed to existing non-c	compliant acces	S	0.0	0.0.270.0
17	Hazardous Sub	stances	☐ Yes	■ No	3.3.1.2. & 3.3.1.19	9.10.1.3(4)
		Horizontal Assemblies	I		0.0.1.2. 0.0.0.1.10	(1)
18	Required Fire Resistance Rating (FRR)	Resistance Resistance Resistance			3.2.2.2083 & 3.2.1.4	9.10.8 9.10.9
		Members 0 Hours				
	Spatial Sepa	ration / Construction of		1	3.2.3	9.10.14
	Wall	Area of EBF (m²)	Limiting Distance	L/H or H/L	Permitted Max. % of Openings	Proposed % of Openings
	North		85.48m		or Openings	Openings
	South		22.86mm		100% (3.2.3.11)	100%
	East		116.45m		10070 (0.2.0.11)	10070
	West		150m			
19						
	Wall	FRR (Hours)	Listed Design No. or Description	Non-Combustibility Required for: Constructio / Cladding or Neither	Non-combustible Construction Provided	Non-combustibl Cladding Provid
	North					
	South East				+	+
	West				+	+
	Health Require	nents	l		3.7	
20		e Mechanical Engineeri	ng Drawings.		1	
_0		res - See drawing A101		washroom notations	3.7.4	9.31.
	·	ments within Floor Area	•		3.3	
21	Separation of S		-	N/A	3.3.1.1	9.10.9.14
	Egress Require			See item 27 below.	3.3.1.5	9.9.9.1.(1)
	Ū	esign of Access Routes		000 110111 21 2010111		0.0.0(1)
22		s on site plan A100.			3.2.5.4, 5, & 6	
23	Protection of Ex			N/A	A 3.2.3.13	9.9.4
	Wall Exposed t	o Another Wall			A 3.2.3.14	9.10.12.3
25		tion for Vertically Separa	ated Openings		A 3.2.3.17	
	0 0	mergency Power			3.2.7	
26		Engineering Drawings			0.2.1	
26	Safety Require	ments for exits:			3.4	9.9.8/9.9.9
		2 4 2 E (2) and drawing	A 101 for detail	s	Ţ	5.5.5.6.6.6
26 27	Complies with 3					
		For Compliance Analys		rm attached to Building		
	Complies with 3	For Compliance Analyst Permit Application.	sis, see OBC Fo	·		
	Complies with 3	For Compliance Analyst Permit Application. 1. Project Information /	sis, see OBC Fo	·		
27	Complies with 3	For Compliance Analyst Permit Application.	sis, see OBC Fo	·		

CENTRAL PRECAST INC.

The R-Value Calculation of the precast concrete insulated wall panel is carried out as follows: Reference: CPCI Design Manual 4, (6.1.5), and PCI Design Handbook 6, (9.1.5)

	Metric	Imperial
Surface Air Film (Exterior)	0.030	0.17
75mm Normal Density Concrete	0.039	0.30
100mm Styrofoam Panelmate Ultra, Extruded	3.96	22.4
Polystyrene by Dow		
100mm Normal Density Concrete	0.052	0.40
Surface Air Film (Interior)	0.120	0.68
Total Value	4.201	23.95
	RSI (m ² °C/W)	R (ft ² h °F/BTU

CENTRAL PRECAST INC. Joe Zito

SPECIFICATIONS

. SEE PROJECT DESCRIPTION UNDER 'ONTARIO BUILDING CODE (2012) DATA MATRIX' ELSEWHERE ON THIS DRAWING.

3. TIME IS OF THE ESSENCE IN THE EXECUTION AND COMPLETION OF THIS WORK.

- ALL CONTRACTORS SHALL READ AND COMPLY WITH SB-10 PROJECT INFORMATION DETAILED FORMS IDENTIFIED IN ITEM 28 OF THE O.B.C. DATA MATRIX.
- 4. WARRANTY- A 12 MONTH WARRANTY FOR THE WORK OF ALL CONTRACTORS SHALL APPLY FROM THE DATE OF SUBSTANTIAL COMPLETION OF THE WORK, PROVIDE EXTENDED WARRANTIES AS CALLED FOR HEREIN, ON ANY OF THE DRAWINGS OR BY CONTRACT.
- 5. PROVIDE LIABILITY INSURANCE \$/OR BONDING AS REQUIRED BY THE PROJECT MANAGER.
- 6. ALL TENDERS ARE TO BE COMPLETE, INCLUDING ALL TAXES, RELATED PERMITS, FEES. ETC. AND ARE TO BE BASED ON COMPLETE EXAMINATION OF THE DRAWINGS, THE SITE, AND ALL CONDITIONS ESTABLISHED BY THE PROJECT MANAGER AND/OR THE
- DOCUMENTS. THE MAIN BUILDING PERMIT FEE WILL BE PAID DIRECTLY BY THE OWNER. ALL CONTRACTORS SHALL CO-ORDINATE AND CO-OPERATE WITH EACH OTHER, ALLOW ACCESS FOR ANY OWNERS WORK.
- 8 PROTECT ALL WORK FROM DAMAGE. KEEP ALL MATERIALS SECURE. ERECT ALL HOARDING, FENCING, BARRIERS AND SCAFFOLDING AS REQUIRED.
- WORKMANSHIP SHALL BE TO THE BEST STANDARD FOR EACH RESPECTIVE TRADE. ERECT ALL WORK ACCURATELY, SQUARE, SECURE, PLUMB, STRAIGHT, TRUE AND TO ACCEPTED TOLERANCES, PROVIDE AND COMPLY WITH MANUFACTURERS PRINTED INSTRUCTIONS. CARRY ON WORK ONLY IN WEATHER, TEMPERATURE OR ENVIRONMENTAL CONDITIONS ACCEPTABLE TO INDUSTRY STANDARDS, MAKE GOOD ALL EXISTING CONDITIONS AS REQUIRED FOR A COMPLETE JOB. CLEAN ALL WORK AND WORK AREAS ON AN ONGOING
- 10. CO-ORDINATE WITH THE PROJECT MANAGER FOR PHASING OF THE WORK AND OVER-ALL
- 11. CONTRACTORS SHALL ARRANGE FOR & PAY FOR ALL NECESSARY TEMPORARY SERVICES AND FACILITIES. CONSULT WITH THE PROJECT MANAGER ON THESE.

2. SITEWORK

- LEGALLY DISPOSE OFF-SITE ALL DEMOLISHED MATERIAL \$ ITEMS REQUIRING REMOVAL, EXCAVATION, ETC.
- PROTECT ALL EXISTING STRUCTURE AND UTILITIES, CONTACT ALL REQUISITE MUNICIPAL AND UTILITY AUTHORITIES FOR LOCATES, AND CARRY OUT WORK TO THEIR APPROVAL.
- 3. REPLACE AND/OR REPAIR ANY DAMAGE TO PUBLIC OR PRIVATE PROPERTY CAUSED BY HIS CONTRACT AT NO EXPENSE TO THE OWNER
- 4. PROVIDE HOARDINGS, BRACING, SHORING, COVERS, ETC. AS REQUIRED.
- 5. CO-ORDINATE AND CARRY OUT ALL NEW ARCHITECTURAL STRUCTURAL, MECHANICAL, ELECTRICAL, CIVIL ENGINEERING & LANDSCAPE REQUIREMENTS.
- 6. SITE WORK INCLUDES ALL ITEMS SHOWN ON OR READILY INFERABLE FROM THE ARCHITECTURAL, LANDSCAPE, & ENGINEERING SITE PLANS & DETAILS. INCLUDE ALL EXCAVATION, REMOVALS, DEWATERING, SEWER & DRAIN CONNECTIONS, UTILITIES, BACKFILLING, COMPACTION, ROUGH & FINISHED GRADING, PAVING, CURBING, LANDSCAPING, ETC. FOR A COMPLETE JOB.
- 7. LAY OUT THE BUILDING BY SURVEY, OBSERVING ALL SETBACKS AND DIMENSIONS SHOWN ON THE ARCHITECTURAL SITE PLAN.
- 8. DO NOT COVER-UP ANY WORK UNTIL PROPERLY INSPECTED BY THE PERTINENT CONSULTANT AND/OR AUTHORITY.
- 9. OBTAIN APPROVAL FROM THE GEOTECHNICAL ENGINEER FOR ALL BEARING SURFACES, BACKFILL MATERIALS AND COMPACTION. SEE ALSO STRUCTURAL DETAILS.

- 1. SEE APPLICABLE STRUCTURAL AND CIVIL ENGINEERING DRAWINGS & DETAILS.
- NEW PRECAST CONCRETE:
 TO BE MANUFACTURED BY AN APPROVED.
- .1 PRECAST CONCRETE ITEMS TO BE MANUFACTURED BY AN APPROVED MANUFACTURER ACCEPTABLE BY THE OWNER
 .2 PROVIDE AND INSTALL PRECAST CONCRETE WHERE SHOWN ON OR IMPLIED BY THE DRAWINGS. THE PRECAST CONCRETE SUB-CONTRACTOR AND HIS AGENTS SHALL BE FULLY RESPONSIBLE FOR THE DESIGN AND ADEQUACY OF THE PRECAST CONCRETE TO CARRY ALL LOADS TO WHICH IT WILL BE SUBJECTED.
 .3 OUTLINES OF PRECAST CONCRETE SECTIONS ARE SHOWN ON THE DRAWINGS. DETAILS OF REINFORCEMENT AND CONNECTIONS (WITH SOME EXCEPTIONS) ARE NOT SUBJECT ON THE DESIGNATION.
- NOT SHOWN. PROVIDE THIS INFORMATION AS REQUIRED ON SHOP DRAWINGS
 BEARING THE SEAL AND SIGNATURE OF AN ONTARIO STRUCTURAL ENGINEER.

 4 PROVIDE SAMPLE UNITS FOR THE APPROVAL OF THE ARCHITECT, THE PROJECT
- MANGER, AND THE OWNER

 5 PROVIDE INSPECTIONS, AND CERTIFICATION OF THE PRECAST INSTALLATIONS BY AN ONTARIO STRUCTURAL ENGINEER.

4. MASONRY - N/A

5. METALS

1. SEE APPLICABLE STRUCTURAL ENGINEERING DRAWINGS & DETAILS.

- 2. INTERIOR METAL WALL W3: SEE DETAILS ON DRAWINGS
- 3. SUPPLY AND INSTALL ALL MISCELLANEOUS METAL AS SHOWN ON THE DRAWINGS. SHOP PRIME AND TOUCH UP WELDS IN THE FIELD.
- 4. PROVIDE SHOP DRAWINGS OF ALL ITEMS FOR THE ARCHITECT'S REVIEW.
- DESIGN DRAWINGS SIGNED AND SEALED BY AN ONTARIO STRUCTURAL ENGINEER FOR

ALL CONNECTIONS, LOADS, ETC. AS REQUIRED BY SECTION 4 OF THE ONTARIO BUILDING CODE, AND INSPECTIONS DURING CONSTRUCTION AND FINAL CERTIFICATION BY THE ENGINEER THAT THE INSTALLATION HAS BEEN COMPLETED IN ACCORDANCE WITH THE REVIEWED DESIGN DRAWINGS.

6. CARPENTRY

- SUPPLY & INSTALL ROUGH CARPENTRY AS REQUIRED FOR A COMPLETE PROJECT, INCLUDING ALL FRAMING, PLYWOOD, SHEATHING, SETTING OF ROUGH BUCKS, CANTS, CURBS, SLEEPERS, VAPOUR BARRIER, HATCHWAYS, STRAPPING, FURRING, METER EQUIPMENT BOARDS, DOORS AND TRIM, HARDWARE, FLASHING, INSULATION, ETC. INSTALL NAILS, SCREWS, BOLTS AND SUNDRY ANCHORS AS REQUIRED FOR SOUND CONSTRUCTION. USE APPROVED NON-CORROSIVE FASTENERS WHEREVER THERE IS THE POSSIBILITY OF STAINING OR CORROSION. EXAMINE THE DRAWINGS TO DETERMINE THE TOTAL SCOPE OF THIS WORK, AND PROVIDE SHOP DRAWINGS FOR THE ARCHITECTS REVIEW.
- 2. ALL BUILT-IN WOOD BLOCKING, CURBS, GROUNDS, NAILERS, ROUGH BUCKS, ETC. TO BE BUILT OF PRESSURE-TREATED LUMBER OR PLYWOOD. APPLY WOOD PRESERVATIVE TO ALL CUT SURFACES.
- 3. ALL POLY VAPOUR/MOISTURE BARRIER TO CONFORM TO CGSB-51.34. ENSURE CONTINUOUS SEAL TO STRUCTURE. SEAL ALL JOINTS WITH 4" MIN. LAP.

7. THERMAL AND MOISTURE PROTECTION

- ROOFING SHALL BE APPLIED IN STRICT ACCORDANCE WITH MANUFACTURERS INSTRUCTIONS, GOOD PRACTICE AND THE CODE OF THE CANADIAN ROOFING CONTRACTORS ASSOCIATION. COMPLY WITH TERMS OF REFERENCE ESTABLISHED
- PROVIDE A 24 MONTH CRCA WARRANTY FOR MATERIAL AND LABOUR, AND A 20-YEAR ROOF SYSTEM WARRANTY.
- 3. SEE DIVISION 15, "MECHANICAL" FOR ROOF DRAIN HARDWARE AND OTHER ROOFTOP EQUIPMENT, VENTS, PENETRATIONS, ETC.
- 4. STANDARD OF ACCEPTANCE: 2-PLY SBS MODIFIED BITUMEN BY IKO.
- 5. SUPPLY+ INSTALL KRAFT PAPER VAPOUR PROTECTOR BY ATLANTIC COATED PAPERS (ACP), BITUMEN RESISTANT TYPE II VAPOUR RETARDER IN ACCORDANCE WITH CAN/CGSB SI-33-M89, CONSISTING OF A KRAFT/ASPHALT / KRAFT LAMINATION, EDGE REINFORCED WITH FIBERGLASS STRANDS AND DEMONSTRATING A TYPICAL MOISTURE VAPOUR TRANSMISSION RATE OF 0.5 PERMS ACCORDING TO
- 6. MECHANICALLY FASTEN ISO-BOARD INSULATION TO R30 WITH FM RATED FASTENERS AND PLATES. 7. SUPPLY + INSTALL IKO FAST-N-STICK 180 BASE SHEET, MECHANICALLY FASTENED WITH OMG
- HEAVY-DUTY ROOFING FASTENERS (#14) WITH CR-10 CORROSION RESISTANT COATING. HEAT-WELD SIDE LAPS AS PER MANUFACTURING INSTRUCTIONS. 8. SUMP ALL ROOF DRAINS BY BY USING TAPERED FIBREBOARD SUMPS FOR A 4'x4' PERIMETER.
- 9. SUPPLY + INSTALL TORCH-ON CAP SHEET IKO TORCHFLEX TP-250-CAP, DE GRANULATE MEMBRANE AT END LAPS, ALLOW FOR MIN. 6" OVERLAP. PROVIDE 1/4" BITUMEN BLEED-OUT @ MEMBRANE SEAMS. 10. SUPPLY AND INSTALL ON PERIMETERS AND INSTALL 2-PLY MODIFIED BITUMEN
- FLASHINGS (IKO TORCHFLEX TP-180-FF-BASE SHEET TORCHED INTO PLACE + IKO TORCHFLEX TP-250-CAP TORCHED INTO PLACE) AT ALL PARAPETS, PENETRATIONS AND ALL BUILDING EXPANSION JOINTS. COMPLETE WITH 26-GAUGE PREFINISHED METAL CAP.
- 11. SUPPLY AND INSTALL NEW PLUMBING STACKS, TALL CONES, PITCH POCKETS AND ROOF DRAINS WITH COPPER INSERTS, U-FLOW SEALS AND BASKETS. 12. FABRICATE AND INSTALL NEW 26 GAUGE PRE-FINISHED METAL FLASHING THROUGHOUT
- PERIMETER AND CURBS, NEW PERIMETER FLASHING FASCIA PROFILE TO BE EXTENDED TO 12".

COLOR TO BE SPECIFIED BY MCON (IDEAL ROOFING). 2. INSULATION

- 1. INSULATE WHERE INDICATED ON OR REASONABLY INFERABLE FROM THE DRAWINGS AS NECESSARY FOR A COMPLETE JOB, INCLUDING BUT NOT NECESSARILY LIMITED TO THE
- FOLLOWING LOCATIONS: FOUNDATIONS - STYROFOAM BY DOW CHEMICAL OF CANADA LTD.
- 2. THERMAL INSULATION WHERE REQUIRED.
 CSA A101, TYPE 1, BATT OF BLANKETS, INORGANIC
 GLASS OR MINERAL FIBRE BY ROXUL INC. OR THERMAC BATT BY OWENS
- 3. FIRE RATED/ACOUSTICAL INSULATION N/A 4. ROOF SEE 7.1 ABOVE. 5. DIV. 15 ITEMS (SEE MECHANICAL DRAWINGS AND SPECIFICATIONS).

3. FIRESTOPPING - N/A

4. CAULKING AND SEALING

CAULK AND SEAL TO ENSURE A COMPLETE WEATHER AND WATERTIGHT PROJECT, INCLUDING AROUND ALL EXTERIOR DOOR AND WINDOW FRAMES, LOUVRES, VENTS, THRESHOLDS, ETC., AND BETWEEN DIFFERENT EXTERIOR MATERIALS, PACK SPACES DEEPER THAN 13 MM (1/2") AND WIDER THAN 6 MM (1/4") WITH CLOSED-CELL POLYETHYLENE ROD FILLER. FIRESTOP AS PER SPECIFICATIONS ABOVE.

- EXTERIOR SEALANT: TWO PART POLYTREMCLYNE TERPOLYMER. EQUAL TO DYMERIC BY TREMCO CANADA LTD. OR DOW CORNING 790 SILICONE BUILDING
- 2. WASHROOM SEALANT: N/A . INTERIOR SEALANTS EQUAL TO 'ACRYLIC LATEX CAULK' BY TREMCO CANADA LTD. BEDDING MATERIAL: ETHAFOAM CLOSED-CELL POLYETHYLENE ROPE, SIZED TO ALLOW 25% (MIN) COMPRESSION WHEN INSERTED IN JOINT.
- 5. PRIMERS: AS RECOMMENDED BY THE SEALING MANUFACTURERS. 6. COLOURS: TO MATCH ADJACENT MATERIALS AND TO ARCHITECTS APPROVAL.

8. DOORS AND WINDOWS

- SUBMIT SHOP DRAWINGS & SCHEDULES OF ALL ITEMS HEREIN FOR ARCHITECTS REVIEW. 2. SUPPLY AND INSTALL ALL PRESSED STEEL FRAMES AND HOLLOW METAL DOORS AS SHOWN
- 3. PRESSED STEEL FRAMES TO BE 16 GA., SATIN-COATED GALVANIZED STEEL A25, READY FOR
- 4. HOLLOW METAL DOORS TO BE 20 GA., SATIN-COATED GALVANIZED STEEL A25, READY FOR PAINT.
- 5. ALL EXTERIOR FRAMES & DOORS TO BE INSULATED. 6. PROVIDE 5-YEAR WARRANTY FOR ALL SEALED GLASS UNITS AGAINST FAILURE OF SEAL AND/OR
- DEPOSITS ON INNER FACE DETRIMENTAL TO VISION.
- ALUM WINDOWS STANDARD OF ACCEPTANCE: KAWNEER 518 SERIES CAW CLEAR SEALED DOUBLE-GLAZED UNITS, LOW-E, ON 3RD SURFACE ARGON FILLED, ALL FINISHES TO BE CLEAR ANODIZED. ALL WORK COMPLETED WITH REQUISITE NON-CORROSIVE FASTENERS, BRACES, TRIMS+CAULKING U-0.45, SHGC=0.40
- 8. SUPPLY & INSTALL ALL HARDWARE AS PER THE GENERIC D/F/H SCHEDULE. SUBMIT HARDWARE SCHEDULE FOR ARCHITECTS REVIEW. PROVIDE KEY SYSTEMS & KEYS AS REQUIRED BY THE OWNER.
- 9. OVERHEAD DOORS SUPPLY & INSTALL SECTIONAL OVERHEAD DOORS AS SHOWN FOR A COMPLETE JOB. INCLUDE SUPPLY AND INSTALLATION OF ALL STEEL PLATES, BLOCKING, ETC. REQUIRED FOR MOUNTING. 10. OVERHEAD DOORS STANDARD OF ACCEPTANCE:
 THERMALEX 2000 BY UPWARDER, TX450 VERTICAL LIFT WITH THERMAL WINDOWS MODEL R1126,
 WHITE FRAME, INSULATED, PREFIN. "ICE WHITE" BAKED ON POLYESTER ENAMEL FINISH ON 26 GA.
 GALV. STEEL. JACK SHAFT OPERATOR CAW 3" HEAVY DUTY HARDWARE, CONTINUOUS ANGLE,
- DOUBLE ENDED HINGES, 100,000 CYCLE SPRING, PRECISION BEARING I'S SOLID SHAFT ALUM VINYL WEATHERSTRIPPING, PNEUMATIC SAFETY DEVICE, THRU-BEAM PHOTO CELL. ELECTRICAL OPERATOR PRO HDD. 1/2 HP. SIZES VARY, SEE D/F/H SCHEDULE.

10. SPECIALTIES - N/A

NOTES:

Contractor shall check and verify all dimensions on site and report any discrepancies to the Architect before proceeding.

| Registered Owner:

M CON PRODUCTS INC.

2150 RICHARDSON SIDE ROAD OTTAWA, ONTARIO, KOA 1LO Tel: (613) 831-1736 ext. 262 Fax: (613) 831-2048 e-mail:john.mion@mconproducts.con

| Project Manager:

ARGUE CONSTRUCTION LTD. 105 WILLOWLEA RD.

CARP, ON. KOA 1LO Tel: (613) 831-7044 Fax: (613) 831-6344

e—màil: kéith@argueconstruction.co

|Structural Engineer: D&S DESIGN & SYSTEMS

2378 HOLLY LANE OTTAWA, ONTARIO, K1V 7P1 Tel: (613) 739-7482

e-mail:gord.bowman@gmail.com


| Mechanical/Electrical Engineer:

Fax: (613) 739-0617

M & E ENGINEERING 205 KINCARDINE DRIVE

OTTAWA, ONTARIO, K2V 1C5 Tel: (613) 836-2184 Fax: (613) 836-3742 e—mail: massoud@meengineering.ca

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383 Parkdale Avenue, Suite 201 Ottawa Ontario Canada K1Y 4R4

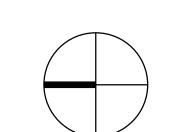

(613) 238-2117 (613) 238-6595

detail no. sheet no.

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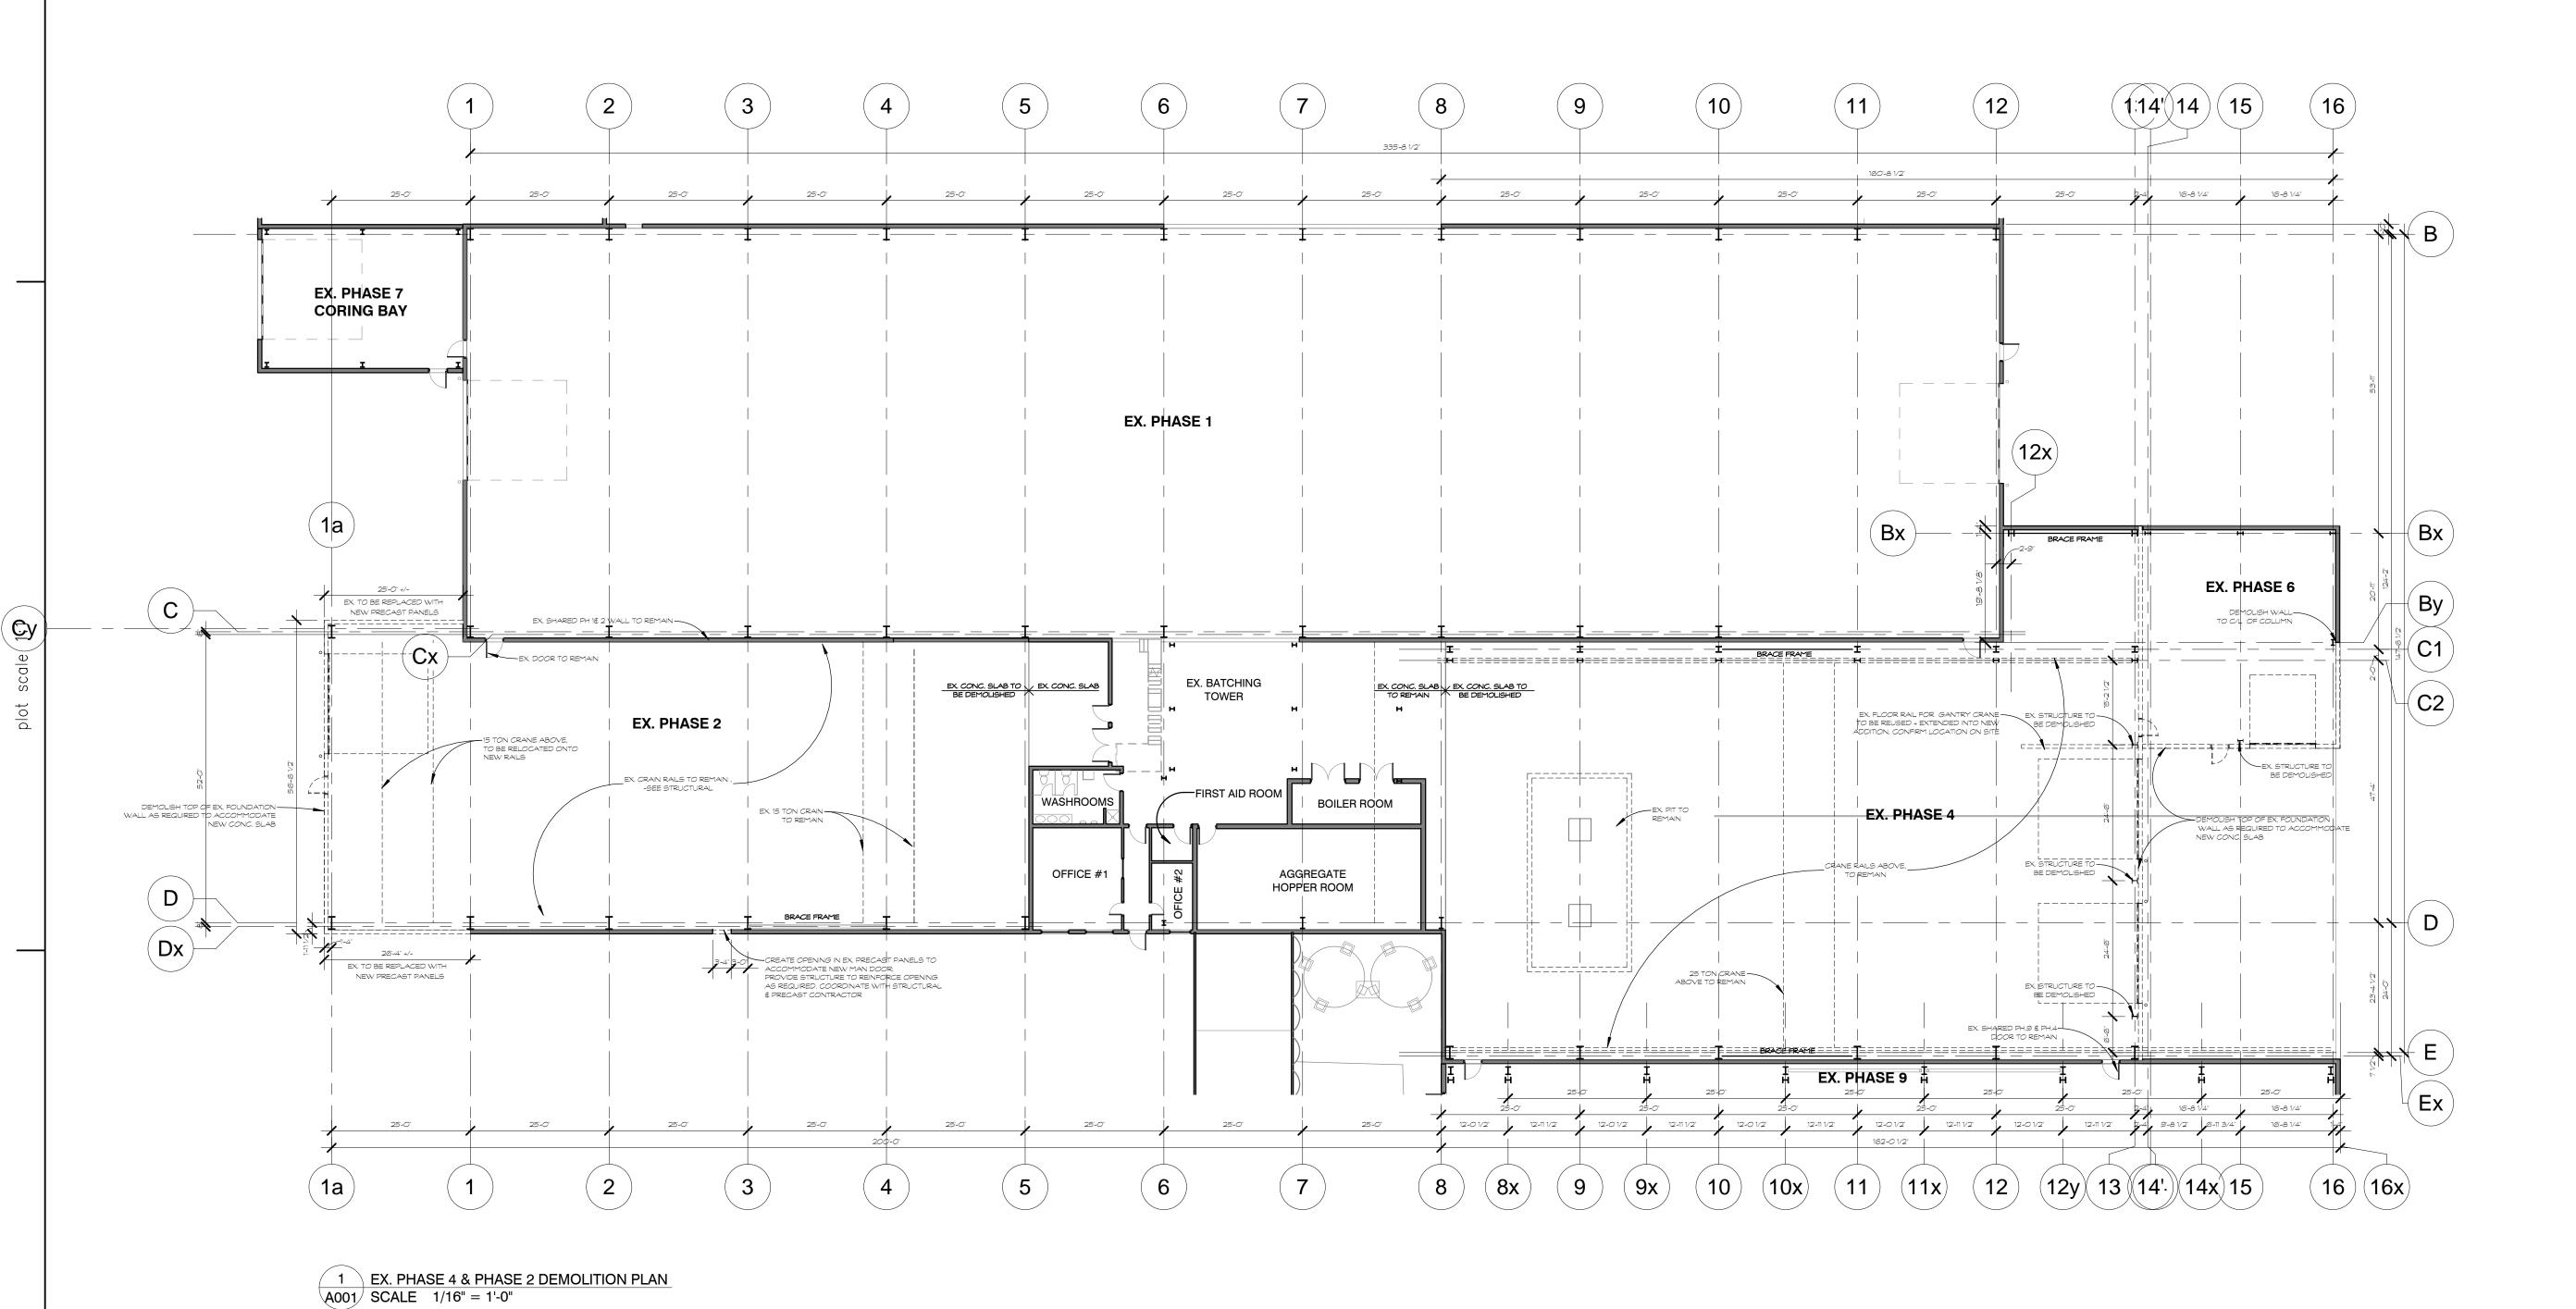
M-CON PHASE 2 & 4 **EXTENSIONS**

2640 CARP RD. OTTAWA, ON K0A 1L0

designed by conçu par		approved by approuvé par
drawn by dessiné par	А.Н	project no. no. du projet 1712
date	23 MARCH 2017	scale as noted

drawing / dessin

LOCATION PLAN, LIST OF CONTRACT DOCUMENTS, **SPECIFICATIONS, OBC (2012)**



Contractor shall check and verify all dimensions on site and report any discrepancies to the Architect before proceeding.

GENERAL LEGEND

A.F.F. - ABOVE FINISHED FLOOR
BF - BARRIER FREE
B/S - BOTH SIDES
CJ - CONTROL JOINT
C/W - COMPLETE WITH
D/F/H - DOOR/FRAME/HARDWARE
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N.I.C. - NOT IN CONTRACT

N.T.S. - NOT TO SCALE
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U/C - UNDER COUNTER
U/N - UNLESS NOTED

OTHERWISE U/S - UNDERSIDE WR - WATER RESISTANT

PROJECT SPECIFIC

ALUM - ALUMINUM

CONC - CONCRETE

CL. - CLEAR ANODIZED

ANOD

FD - FLOOR DRAIN

GWB - GYPSUM WALL BOARD

HM - HOLLOW METAL


PSF - PRESSED STEEL FRAME

RD - ROOF DRAIN ST.ST. - STEEL STUDS

O ISSUED FOR TENDER 04 MAY 2013

O ISSUED FOR PERMIT 23 MAR 2013

no. revision date

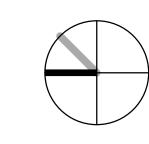

detail no.

sheet no.

ARCHITECTS Z

MANUAL

RALPH WIESBROCK

LICENCE

5270

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NO ASSOC

383 Parkdale Avenue, Suite 201 Ottawa Ontario Canada K1Y 4R4 KWC ARCHITECTS INC.

PHONE (613) 238-2117 FAX (613) 238-6595

E MAIL kwc@kwc-arc

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feuille no.

détail no.

M-CON PHASE 2 & 4 EXTENSIONS


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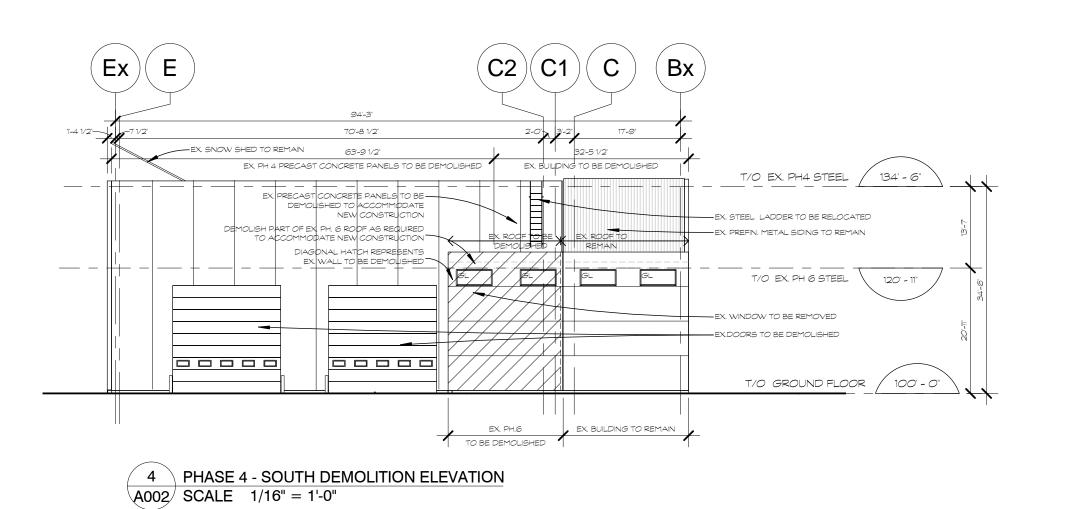
2640 CARP RD.


drawn by dessiné par				project no. no. du projet		
			A.H			1712 ———
date				scale		
	23	MARCH	2017		as	noted

PHASE 2/4 DEMOLITION PLAN

revision sheet no. révision no. de la feuille



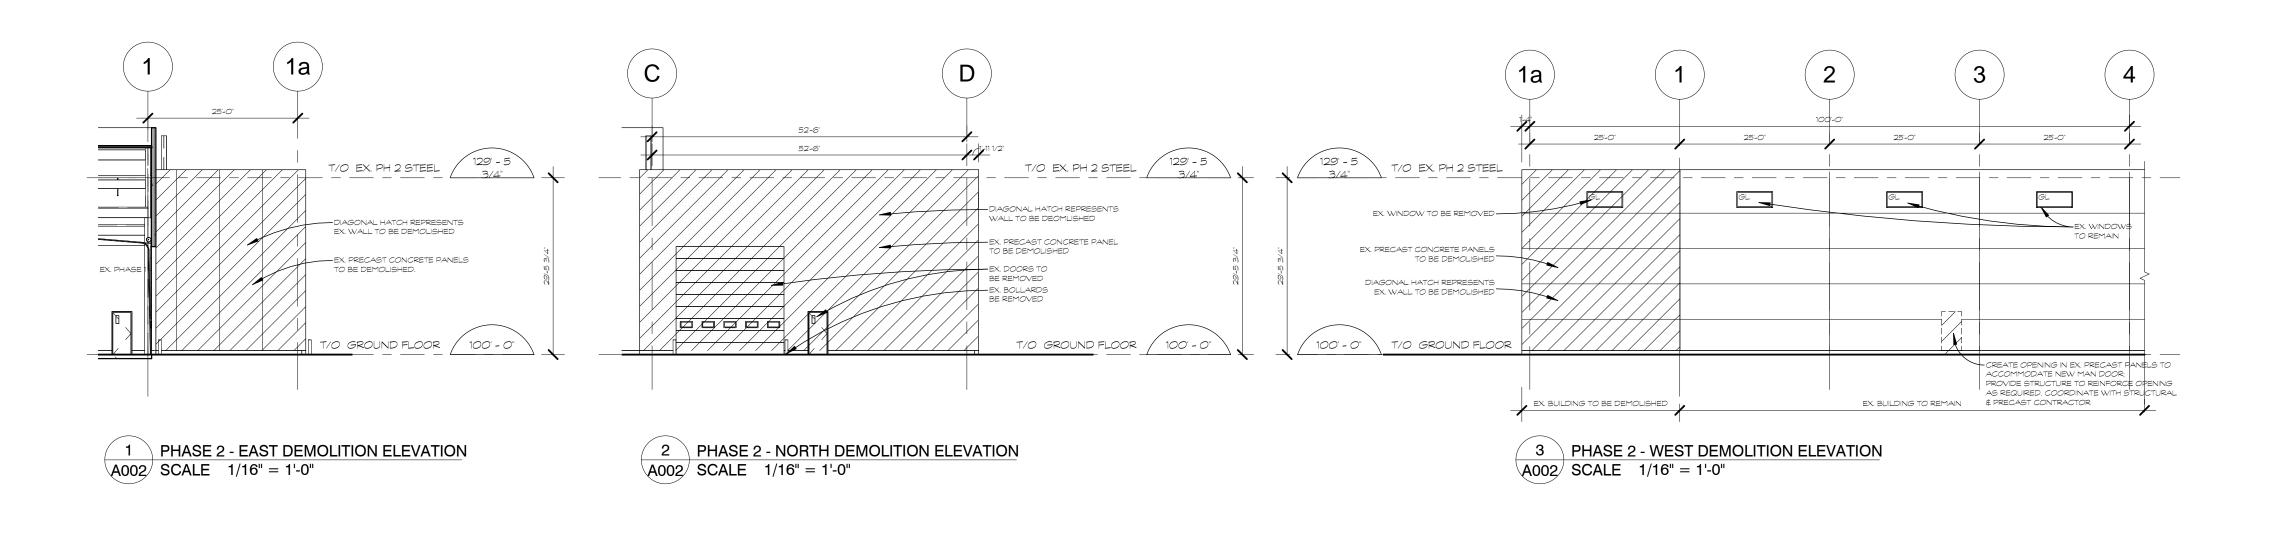

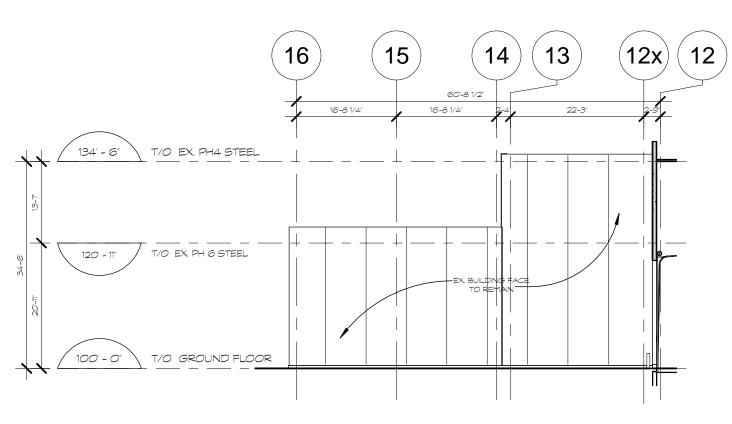

5 PHASE 4 - EAST DEMOLITION ELEVATION A002 SCALE 1/16" = 1'-0"

Contractor shall check and verify all dimensions on site and report any discrepancies to the Architect before proceeding.

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ISSUED FOR TENDER 04 MAY 2017 O . ISSUED FOR PERMIT



date

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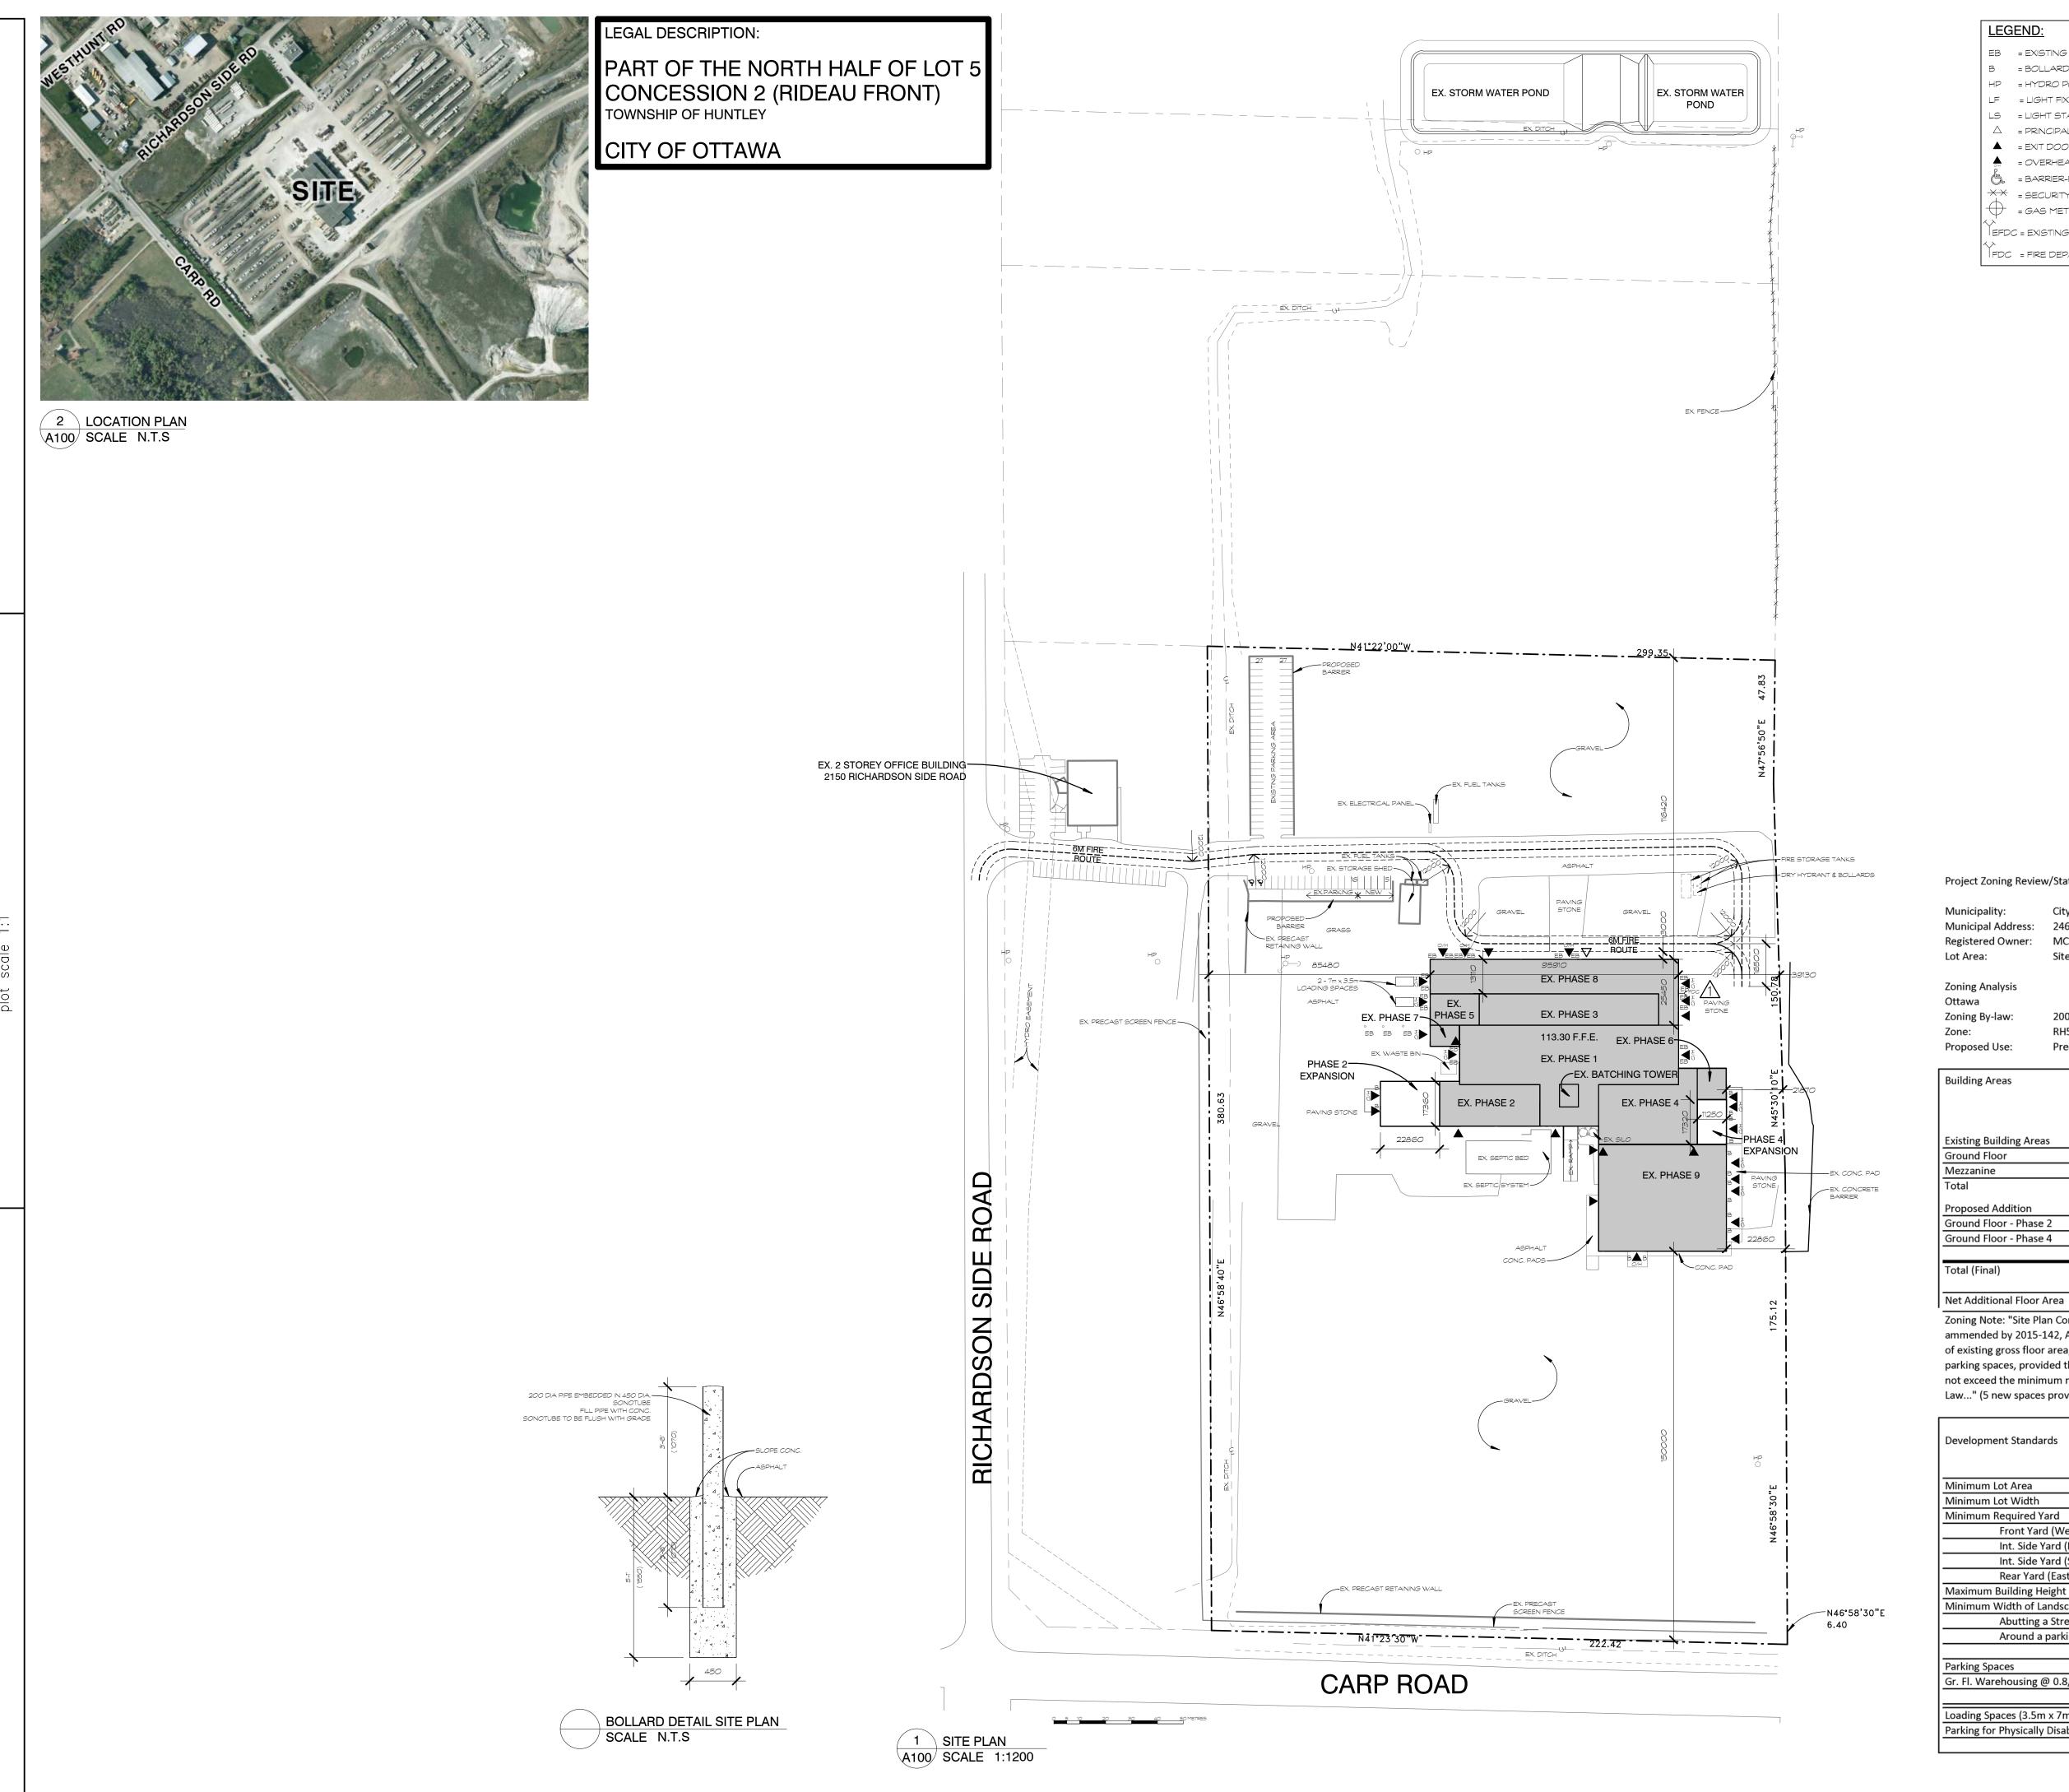
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M-CON PHASE 2 & 4 **EXTENSIONS**

2640 CARP RD. OTTAWA, ON KOA 1LO

designed by conçu par				approved by approuvé par		
drawn by dessiné par			A .H	project no. no. du projet		1712
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EX. PHASE 2 & 4 DEMOLITION ELEVATIONS



LEGEND:

EB = EXISTING BOLLARD

B = BOLLARD

HP = HYDRO POLE LF = LIGHT FIXTURE - EXTERIOR, WALL MOUNTED

LS = LIGHT STANDARD

 \triangle = PRINCIPAL ENTRANCE = EXIT DOOR

= OVERHEAD DOOR

= BARRIER-FREE PARKING SPACE C/W PAINTED LOGO & SIGN

** = SECURITY FENCING AND GATE = GAS METER

EFDC = EXISTING FIRE DEPARTMENT CONNECTION

FDC = FIRE DEPARTMENT CONNECTION

Registered Owner:

M CON PRODUCTS INC. 2150 RICHARDSON SIDE ROAD

OTTAWA, ONTARIO, KOA 1LO Tel: (613) 831-1736 ext. 262 Fax: (613) 831-2048 e-mail:john.mion@mconproducts.com

Project Manager:

ARGUE CONSTRUCTION LTD.

105 WILLOWLEA RD. CARP, ON. KOA 1LO Tel: (613) 831-7044 Fax: (613) 831-6344 e—màil: kéith@argueconstruction.c

Geotechnical Engineer:

HOULE CHEVRIER ENGINEERING LTD.

180 WESCAR LANE OTTAWA, ONTARIO, KOA 1LO Tel: (613) 836-1422 Fax: (613) 836-9731 e-mail:lashe@hceng.ca

|Surveyor:

FAIRHALL, MOFFATT & WOODLAND LIMITED

235 TERENCE MATTHEWS CRESCENT OTTAWA, ONTARIO K2M 2B3 Tel: (613) 591-2580 Fax: (613) 591-1495

Project Zoning Review/Statistics

City of Ottawa Municipal Address: 2460 Carp Rd. Registered Owner: MCON Products Inc

Lot Area: Site Area: 84,000sq.m. (904,198 sq.ft (20.75 acres))

Zoning Analysis Ottawa

Zoning By-law: 2008-250 Zone: Precast Concrete Plant Proposed Use:

Building Areas		
	Gross (out-	-to-out)
	Sq.m.	Sq.ft
Existing Building Areas		
Ground Floor	8,563	92,171
Mezzanine	133	1,435
Total	8,696	93,606
Proposed Addition		
Ground Floor - Phase 2	395	4,256
Ground Floor - Phase 4	186	1,997
Total (Final)	9,277	99,859

Zoning Note: "Site Plan Control Approval" not requried: By-Law 2014-256 as ammended by 2015-142, Article 5.(2)(d)i.b. and v. - addition not exceeding 30% of existing gross floor area, to a maximum of 600 sq.m., and 5.(4), "up to nine parking spaces, provided the total number of parking spaces on the lot does not exceed the minimum number of parking spaces reqired by the Zoning By-Law..." (5 new spaces provided)

581 (+6%)

6,253

Development Standards		
	Required	Provided
Minimum Lot Area	8,000 sq.m.	84,000 sq.m.
Minimum Lot Width	50.0m	219.21m
Minimum Required Yard		
Front Yard (West - Carp Rd.)	15.0m	150.0m
Int. Side Yard (North)	3.0m	85.48m
Int. Side Yard (South)	3.0m	21.83m
Rear Yard (East)	15.0m	12.88m
Maximum Building Height	15.0m	12.88m
Minimum Width of Landscaping		
Abutting a Street	3m	Existing
Around a parking lot	nil	Existing
Parking Spaces		
Gr. Fl. Warehousing @ 0.8/100 sq.m.	75	75
		(70 existing)
Loading Spaces (3.5m x 7m)	2	2
Parking for Physically Disabled	1	2

NOTES:

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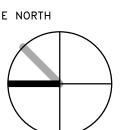
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RD - ROOF DRAIN ST.ST. - STEEL STUDS

ISSUED FOR PERMIT

TRUE NORTH



383 Parkdale Avenue, Suite 201 Ottawa Ontario Canada K1Y 4R4

KWC ARCHITECTS INC.

(613) 238-2117

feuille no.

K0A 1L0

détail no.

drawing / dessin

detail no.


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M-CON PHASE 2 & 4 **EXTENSIONS**

2640 CARP RD. OTTAWA, ON

1712
as noted

SITE PLAN

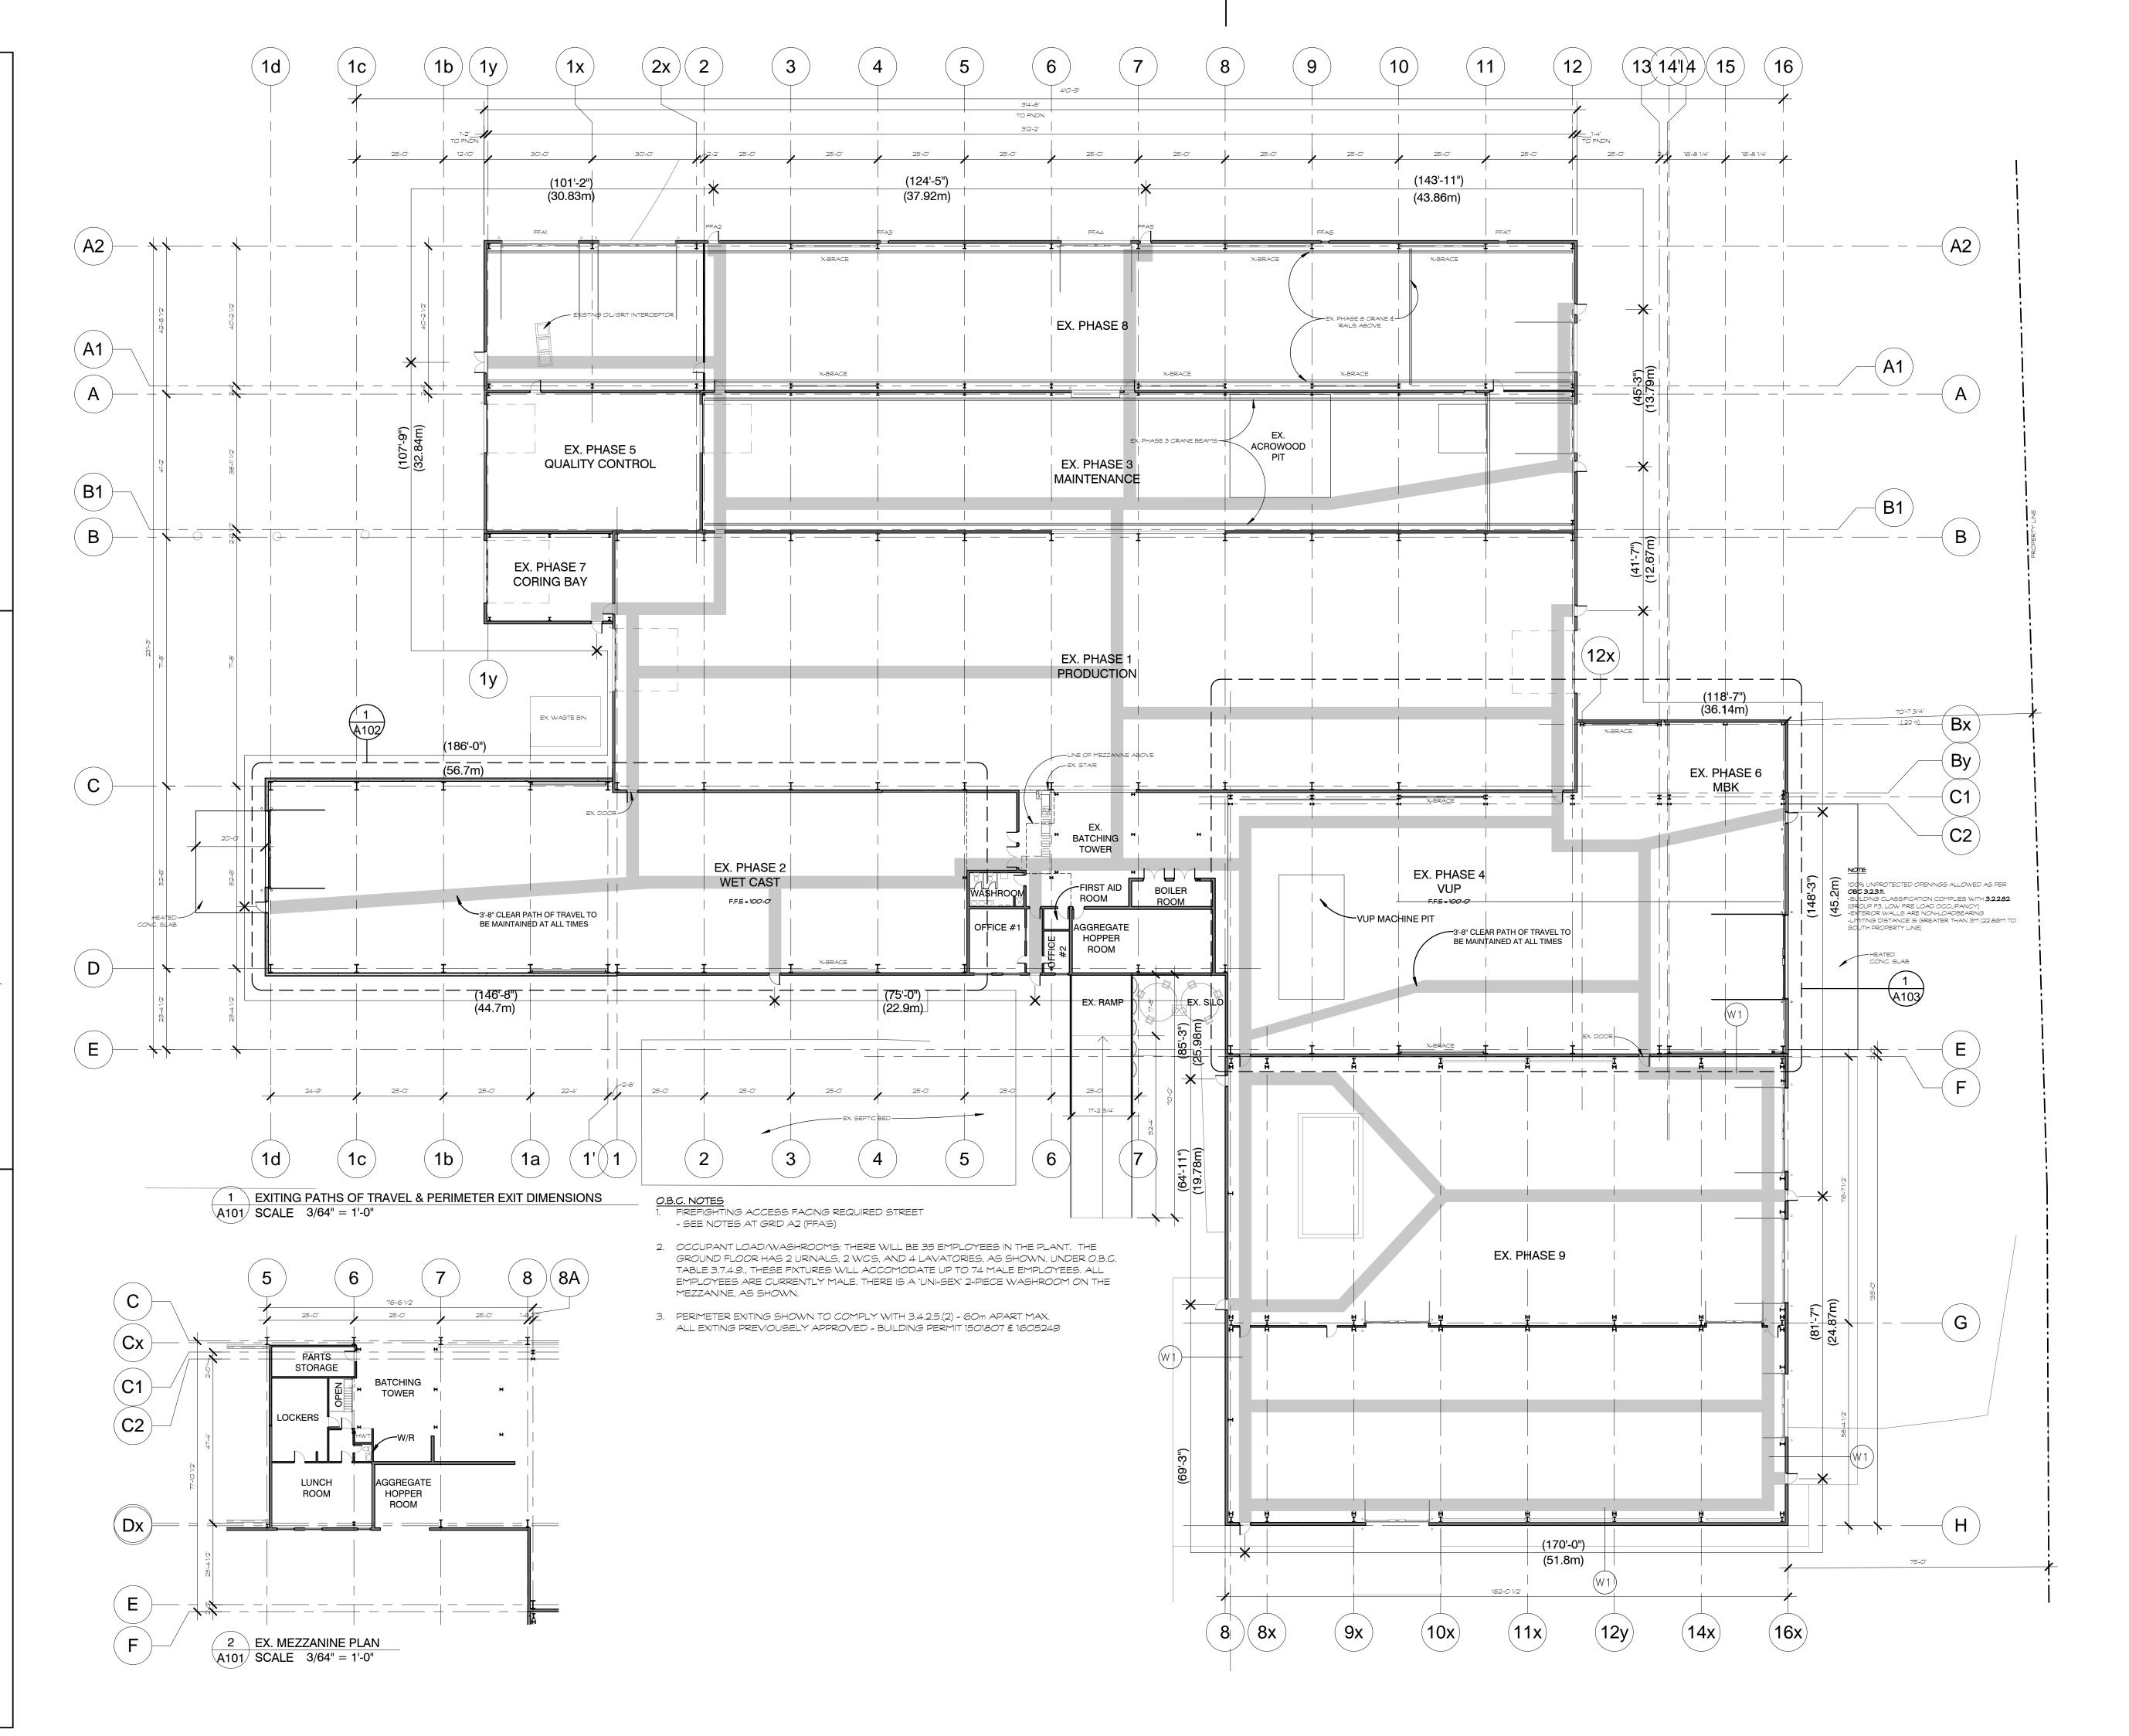

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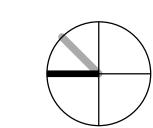
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ISSUED FOR PERMIT date



O ARCHITECTS Z RALPH WIESBROCK LICENCE 5270

NO ASSOC

383 Parkdale Avenue, Suite 201 Ottawa Ontario Canada K1Y 4R4

KWC ARCHITECTS INC.

(613) 238-2117 (613) 238-6595 **E MAIL** kwc@kwc-arch.com

detail no. sheet no.

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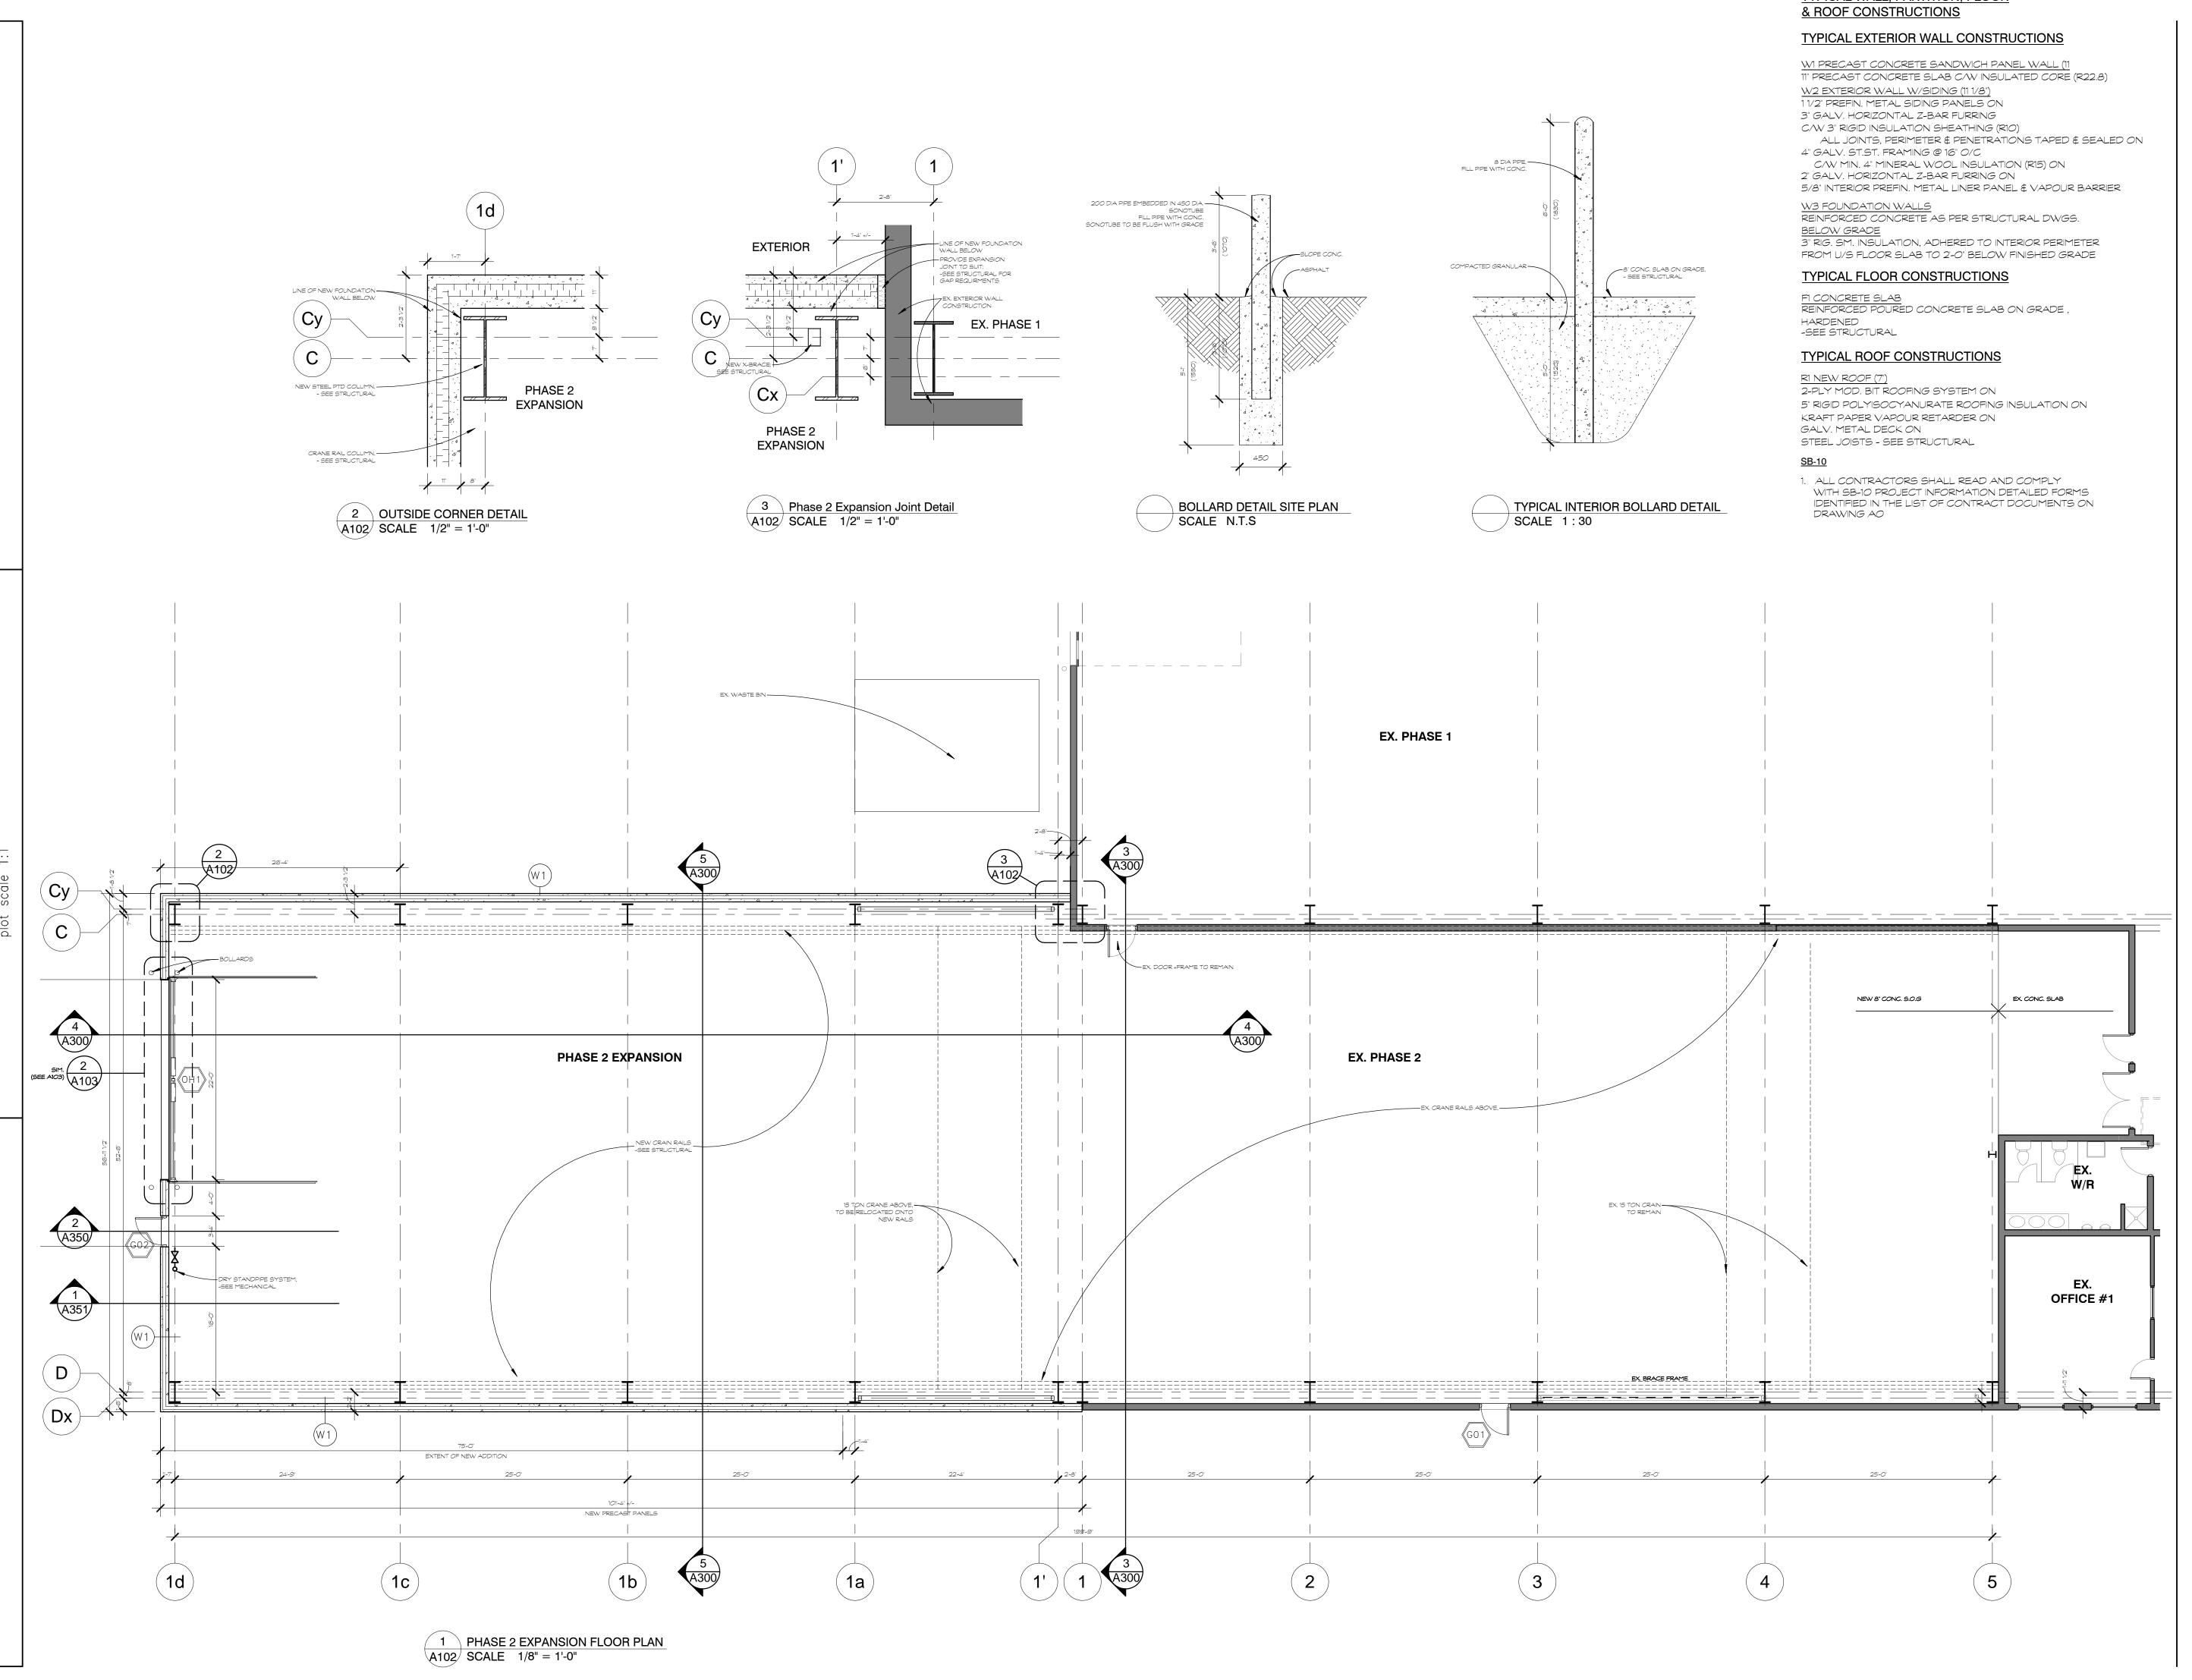
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2640 CARP RD. OTTAWA, ON KOA 1LO

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drawing / dessin

EXITING PATHS OF TRAVEL & PERIMETER EXIT DIMENSIONS



TYPICAL WALL, PARTITION, FLOOR

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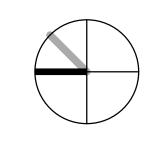
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ST.ST. - STEEL STUDS

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NO ASSOC O ARCHITECTS 2

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KWC ARCHITECTS INC.

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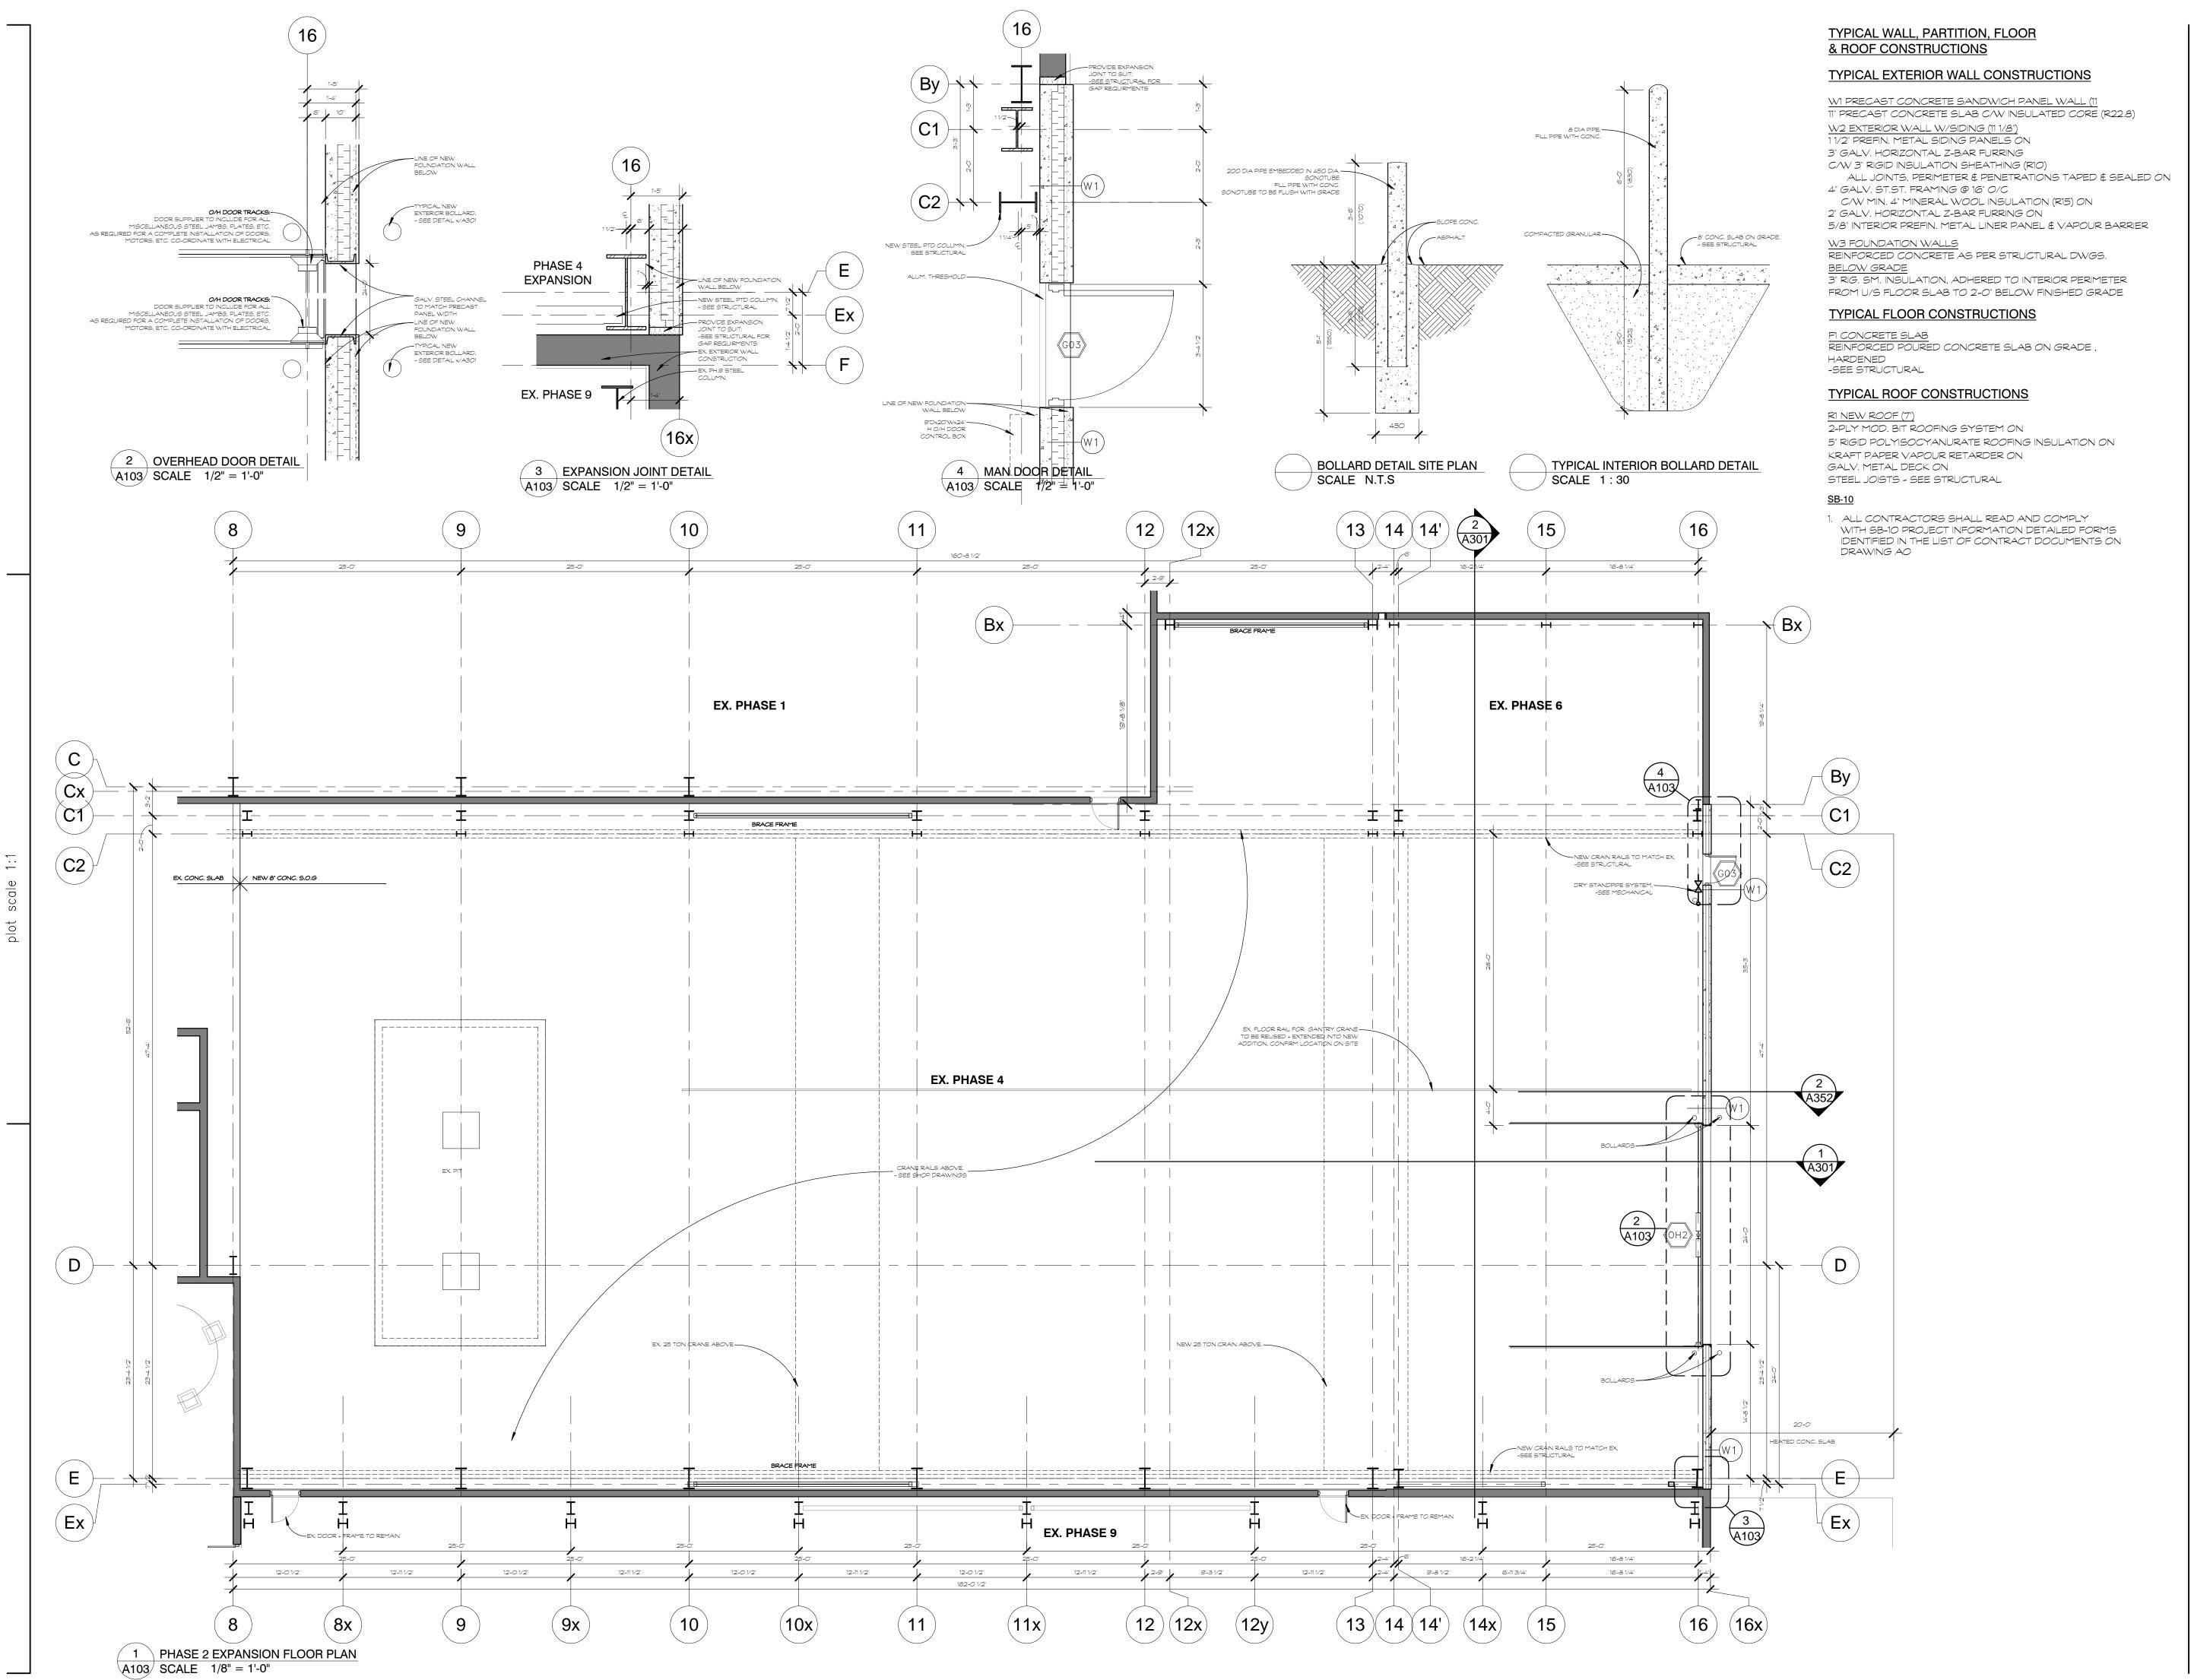
M-CON PHASE 2 & 4 **EXTENSIONS**

2640 CARP RD. OTTAWA, ON K0A 1L0

project no.
no. du projet
A.H 23 MARCH 2017

drawing / dessin

PHASE 2 EXPANSION FLOOR PLAN



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O ISSUED FOR TENDER 04 MAY 20
O ISSUED FOR PERMIT 23 MAR 20
no. revision date

7000 5270

NO ASSOC

383 Parkdale Avenue, Suite 201 Ottawa Ontario Canada K1Y 4R4 KWC ARCHITECTS INC.

PHONE (613) 238-2117

E MAIL kwc@kwc-arch.co

detail no. sheet no. détail no. feuille no.

project projet

M-CON PHASE 2 & 4 EXTENSIONS

2640 CARP RD. OTTAWA, ON K0A 1L0

drawn by dessiné par

A.H

date

23 MARCH 2017

designed by approved by approved par

A.H

project no. no. du projet
scale

as noted

drawing / dessin

PHASE 4 EXPANSION FLOOR PLAN

									HA	ARDWA	ARE NO	TE: ALL	L ELEC	TRONIC	HARDW/	ARE ON	ALL DOC	ORS BY	DOOR &	FRAME	SUPPL	IER		REMARKS	ALUM BR	= Aluminum = Brushed	
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	from	to SIZE		TYPE	STYLE	FINISH	TYPE	FINISH LABE	마의	lockset rim pan	closer	2	es	s 형	g	쓴 근		<u> </u> 2	st di	흥물	[월 .	질등	door		PGWG		
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									<u> </u>	ō∣÷	ਹੋ ਹ	진	ij	티출	g si	¥ ≩	주 흑	အ	ပြု နို	ဗ္ဗီ	{ ত -	ĕ ĕ	No.		SCW	= Solid Core Wood	
GRO	UND FLOOR		·										•									•					
G01	PHASE 2	EXTERIOR 3'-C	D" 7'-0" 13/4"	HM	A	PTD	PSF	PTD		•	*	*				• •							G01	* EXTER	IOR THU	JMB LATCH & HOLD OPEN	V CLOSER
G02	PHASE 2	EXTERIOR 3'-C	D" 7'-0" 13/4"	НМ	A	PTD	PSF	PTD		•	*	*		•		• •							G02	* EXTER	IOR THU	JMB LATCH & HOLD OPEN	N CLOSER
G03		EXTERIOR 3'-C			A	PTD	PSF	PTD		•	*	*	•			• •							G03	* EXTER	IOR THU	JMB LATCH & HOLD OPEN	N CLOSER
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OH1		EXTERIOR 22'-0	0" 22'-0"																								
OH2		EXTERIOR 24-0																									
OH3		EXTERIOR 24-0																									

DOOR WIDTH

DOOR STYLE 'A'

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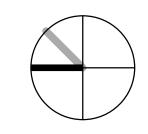
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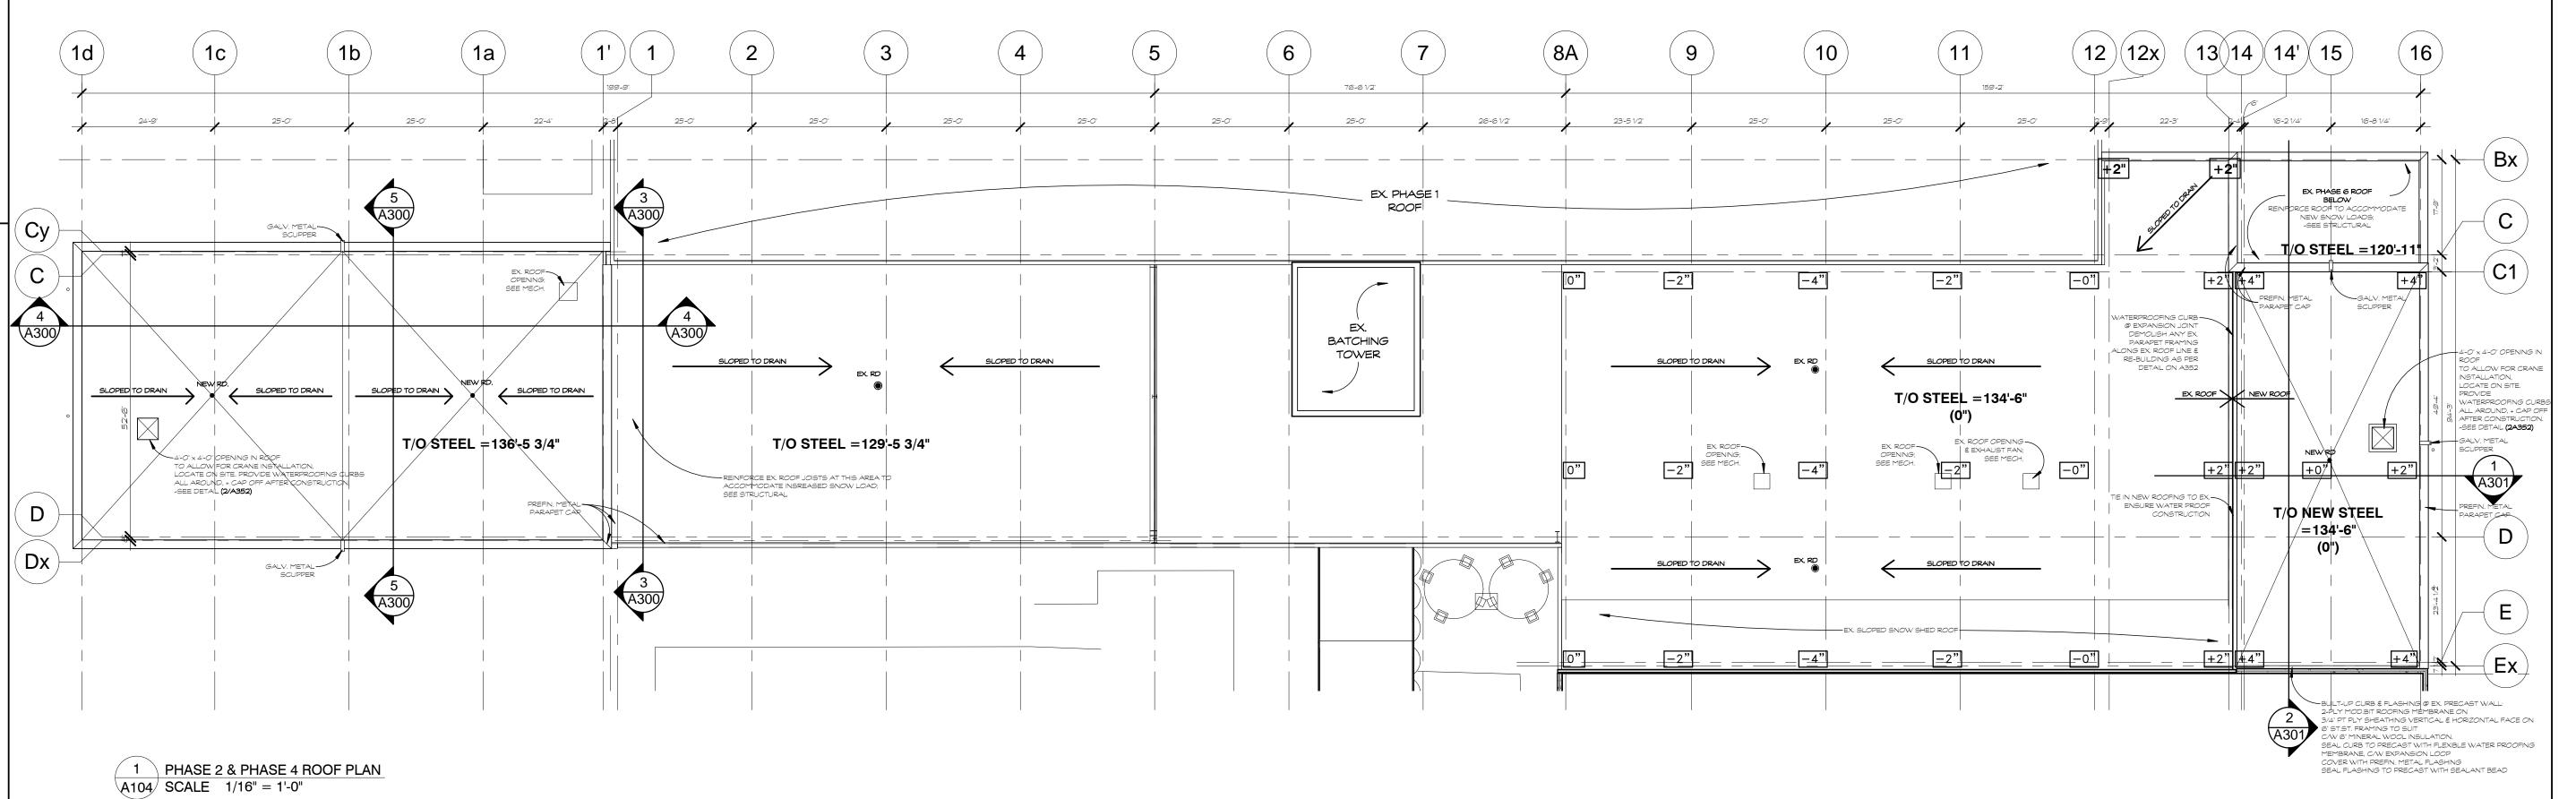
M-CON PHASE 2 & 4 **EXTENSIONS**

> 2640 CARP RD. OTTAWA, ON KOA 1LO

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drawing / dessin

PHASE 2 & 4 ROOF PLAN



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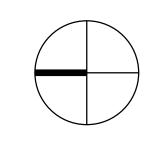
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no.	revision	date



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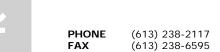
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RALPH WIESBROCK
LICENCE
5270

5270

NO ASSOC

383 Parkdale Avenue, Suite 201 Ottawa Ontario Canada K1Y 4R4 KWC ARCHITECTS INC.



E MAIL kwc@kwc-arch.co

detail no.

sheet no.

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A1

feuille no.

project projet

M-CON PHASE 2 & 4 EXTENSIONS

2640 CARP RD. OTTAWA, ON KOA 1L0

			approved by approuvé par		
		A. H	project no. no. du projet		1712
			scale		
23	MARCH	2017		as i	noted
	23	23 MARCH	A.H 23 MARCH 2017	A.H	A.H project no. no. du projet

drawing / dessin

PHASE 2 CONSTUCTION ELEVATIONS

evision sheet no. no. de la feuille A200

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PROJECT SPECIFIC

ALUM - ALUMINUM CONC - CONCRETE


CL. - CLEAR ANODIZED
ANOD
FD - FLOOR DRAIN
GWB - GYPSUM WALL BOARD
HM - HOLLOW METAL

HM - HOLLOW METAL PSF - PRESSED STEEL FRAME

RD - ROOF DRAIN ST.ST. - STEEL STUDS

O ISSUED FOR TENDER 04 MAY 2017
O ISSUED FOR PERMIT 23 MAR 2017

no. revision

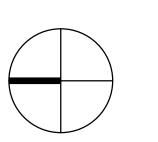

383 Parkdale Avenue, Suite 201 Ottawa Ontario Canada K1Y 4R4

ottawa omano oanaga KTT II

KWC ARCHITECTS INC.

PHONE (613) 238-2117
FAX (613) 238-6595
E MAIL kwc@kwc-arch.coi

détail no.

sheet no.

project projet

drawing / dessin

detail no.

M-CON PHASE 2 & 4 EXTENSIONS


2640 CARP RD. OTTAWA, ON K0A 1L0

feuille no.


			approved by approuvé par		
		A. H	project no. no. du projet		1712
			scale		
23	MARCH	2017		as	noted
	23	23 MARCH	A.H 23 MARCH 2017	A.H project no. no. du projet	A.H project no. no. du projet

PHASE 4 CONSTUCTION ELEVATIONS

revision sheet no. révision no. de la feuille

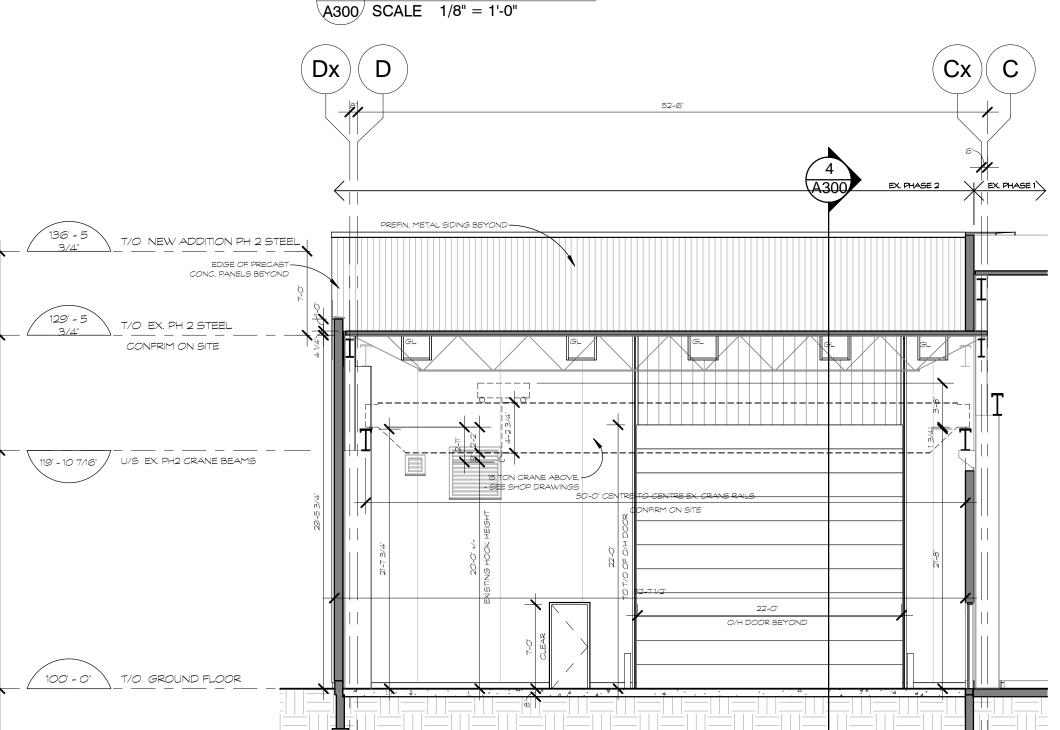

3 PHASE 2 - BUILDING SECTION A300 SCALE 1/8" = 1'-0"

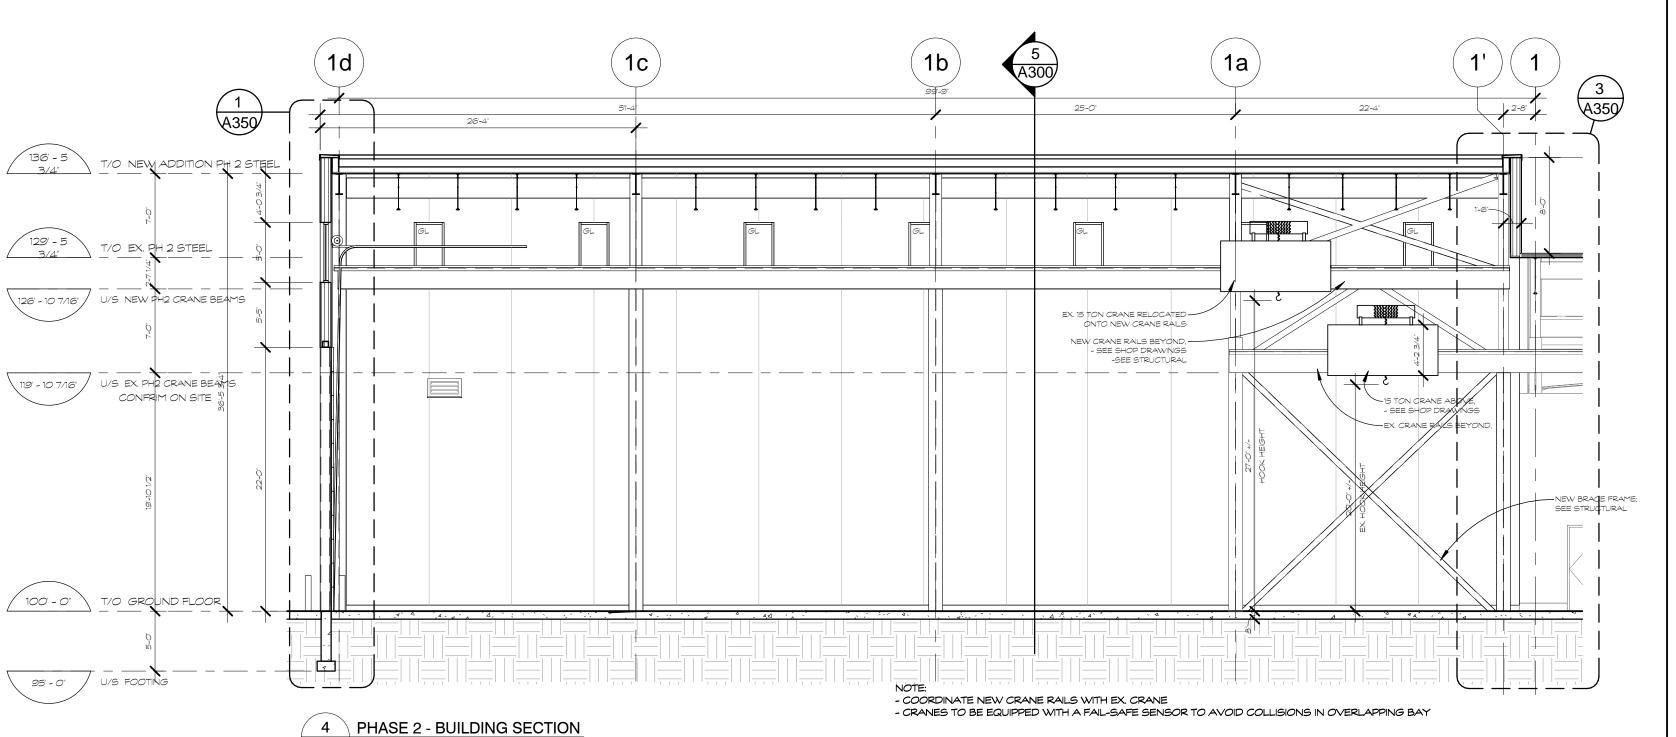

A300 SCALE 1/8" = 1'-0"

TYPICAL WALL, PARTITION, FLOOR <u>& ROOF CONSTRUCTIONS</u>

TYPICAL EXTERIOR WALL CONSTRUCTIONS

WI PRECAST CONCRETE SANDWICH PANEL WALL (11 11" PRECAST CONCRETE SLAB C/W INSULATED CORE (R22.8) W2 EXTERIOR WALL W/SIDING (11 1/8")

1 1/2" PREFIN. METAL SIDING PANELS ON

3" GALV. HORIZONTAL Z-BAR FURRING C/W 3" RIGID INSULATION SHEATHING (R10)

ALL JOINTS, PERIMETER & PENETRATIONS TAPED & SEALED ON 4" GALV. ST.ST. FRAMING @ 16" O/C C/W MIN. 4" MINERAL WOOL INSULATION (R15) ON

2" GALV. HORIZONTAL Z-BAR FURRING ON 5/8" INTERIOR PREFIN. METAL LINER PANEL & VAPOUR BARRIER

W3 FOUNDATION WALLS

REINFORCED CONCRETE AS PER STRUCTURAL DWGS. BELOW GRADE

3" RIG. SM. INSULATION, ADHERED TO INTERIOR PERIMETER FROM U/S FLOOR SLAB TO 2'-0" BELOW FINISHED GRADE

TYPICAL FLOOR CONSTRUCTIONS

<u>F1 CONCRETE SLAB</u> REINFORCED POURED CONCRETE SLAB ON GRADE , HARDENED -SEE STRUCTURAL

TYPICAL ROOF CONSTRUCTIONS

R1 NEW ROOF (7")

2-PLY MOD. BIT ROOFING SYSTEM ON 5" RIGID POLYISOCYANURATE ROOFING INSULATION ON KRAFT PAPER VAPOUR RETARDER ON

GALV. METAL DECK ON STEEL JOISTS - SEE STRUCTURAL

<u>SB-10</u>

1. ALL CONTRACTORS SHALL READ AND COMPLY WITH SB-10 PROJECT INFORMATION DETAILED FORMS IDENTIFIED IN THE LIST OF CONTRACT DOCUMENTS ON DRAWING AO

NOTES:

Contractor shall check and verify all dimensions on site and report any discrepancies to the Architect before proceeding.

GENERAL LEGEND

A.F.F. - ABOVE FINISHED FLOOR BF - BARRIER FREE

B/S - BOTH SIDES CJ - CONTROL JOINT

C/W - COMPLETE WITH

D/F/H - DOOR/FRAME/HARDWARE EQ - EQUAL

EX - EXISTING F.R.R. - FIRE RESISTANCE RATING

N.I.C. - NOT IN CONTRACT N.T.S. - NOT TO SCALE

O/C - ON CENTRES O/H - OVERHEAD

PTD - PAINTED PT - PRESSURE TREATED

U/C - UNDER COUNTER U/N - UNLESS NOTED

OTHERWISE U/S - UNDERSIDE

WR - WATER RESISTANT PROJECT SPECIFIC

ALUM - ALUMINUM CONC - CONCRETE


CL. - CLEAR ANODIZED ANOD FD - FLOOR DRAIN

GWB - GYPSUM WALL BOARD HM - HOLLOW METAL

PSF - PRESSED STEEL FRAME

RD - ROOF DRAIN ST.ST. - STEEL STUDS

ISSUED FOR PERMIT date

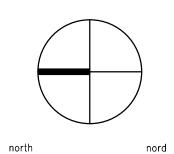



NO ASSOC

OF

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détail no. feuille no.

detail no.

sheet no.

drawing / dessin

M-CON PHASE 2 & 4 **EXTENSIONS**

2640 CARP RD. OTTAWA, ON K0A 1L0

			approved by approuvé par		
		A. H	project no. no. du projet		1712
			scale		
23	MARCH	2017		as	noted
	23	23 MARCH	A.H 23 MARCH 2017	А.Н 	A.H scole

PHASE 2 BUILDING SECTIONS

sheet no.
no. de la feuille

A300

95'-0" / U/S FOOTING

TYPICAL WALL, PARTITION, FLOOR & ROOF CONSTRUCTIONS

TYPICAL EXTERIOR WALL CONSTRUCTIONS

WI PRECAST CONCRETE SANDWICH PANEL WALL (11 11" PRECAST CONCRETE SLAB C/W INSULATED CORE (R22.8) W2 EXTERIOR WALL W/SIDING (11 1/8")

11/2" PREFIN. METAL SIDING PANELS ON 3" GALV. HORIZONTAL Z-BAR FURRING

C/W 3" RIGID INSULATION SHEATHING (R10) ALL JOINTS, PERIMETER & PENETRATIONS TAPED & SEALED ON 4" GALV. ST.ST. FRAMING @ 16" O/C

C/W MIN. 4" MINERAL WOOL INSULATION (R15) ON 2" GALV. HORIZONTAL Z-BAR FURRING ON

5/8" INTERIOR PREFIN. METAL LINER PANEL & VAPOUR BARRIER

W3 FOUNDATION WALLS REINFORCED CONCRETE AS PER STRUCTURAL DWGS.

BELOW GRADE 3" RIG. SM. INSULATION, ADHERED TO INTERIOR PERIMETER FROM U/S FLOOR SLAB TO 2'-0" BELOW FINISHED GRADE

TYPICAL FLOOR CONSTRUCTIONS

 $rac{ extstyle F1 CONCRETE SLAB}{ extstyle REINFORCED POURED CONCRETE SLAB ON GRADE ,}$ HARDENED -SEE STRUCTURAL

TYPICAL ROOF CONSTRUCTIONS


R1 NEW ROOF (7")

2-PLY MOD. BIT ROOFING SYSTEM ON 5" RIGID POLYISOCYANURATE ROOFING INSULATION ON KRAFT PAPER VAPOUR RETARDER ON GALV. METAL DECK ON STEEL JOISTS - SEE STRUCTURAL

<u>SB-10</u>

1. ALL CONTRACTORS SHALL READ AND COMPLY WITH SB-10 PROJECT INFORMATION DETAILED FORMS IDENTIFIED IN THE LIST OF CONTRACT DOCUMENTS ON DRAWING AO

$(\mathsf{E})(\mathsf{Ex})$ (Bx)19'-8 1/4" BUILT-UP CURB & FLASHING @ EX. PRECAST WALL: — BUILT-UP CURB & FLASHING @ EX. PRECAST WALL: 2-PLY MOD.BIT ROOFING MEMBRANE ON 3/4' PT PLY SHEATHING VERTICAL & HORIZONTAL FACE ON 6' ST.ST. FRAMING TO SUIT C/W 6' MINERAL WOOL INSULATION. SEAL CURB TO PRECAST WITH FLYBLE WATER PROOFING MEMBRANE, C/W EXPANSION LOOP COVER WITH PREFIN. METAL FLASHING SEAL FLASHING TO PRECAST WITH SEALANT BEAD 3 A352 134' - 6" T/O EX. PH4 STEEL CONFRIM ON SITE REINFORCE EX. ROOF TO-MMODATE SNOW LOAD: -SEE STRUCTURAL 122 - 6 1/2" U/S EX. PH4 CRANE BEARS 120-17 T/O EX. PH 6 STEEL ·-----PANELS BEYOND 100'-0" \ T/O GROUND FLOOR. NOTE: NEW CRANE RAILS DIMENSIONS TO MATCH EX. COORDINATE ON SITE.

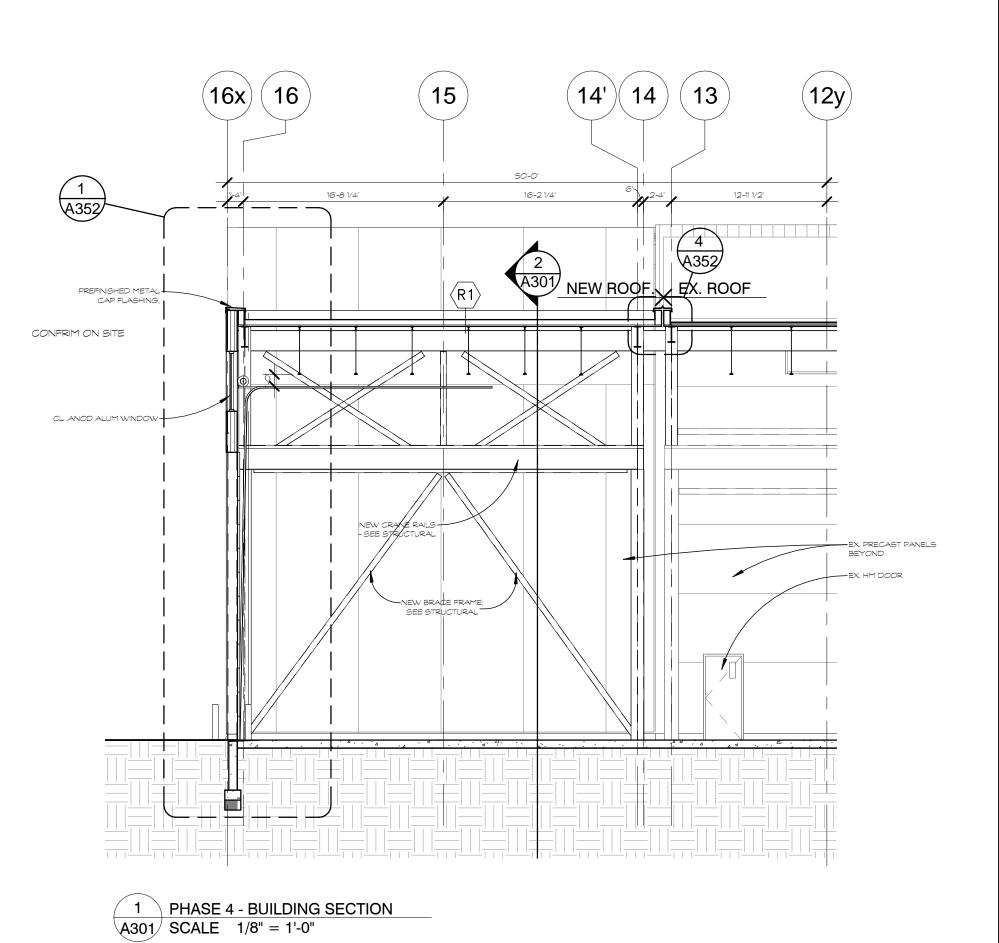

NOTES:

Contractor shall check and verify all dimensions on site and report any discrepancies to the Architect before proceeding.

GENERAL LEGEND

A.F.F. - ABOVE FINISHED FLOOR BF - BARRIER FREE B/S - BOTH SIDES CJ - CONTROL JOINT C/W - COMPLETE WITH

D/F/H - DOOR/FRAME/HARDWARE EQ - EQUAL

EX - EXISTING F.R.R. - FIRE RESISTANCE RATING N.I.C. - NOT IN CONTRACT

N.T.S. - NOT TO SCALE O/C - ON CENTRES O/H - OVERHEAD PTD - PAINTED

U/C - UNDER COUNTER U/N - UNLESS NOTED OTHERWISE U/S - UNDERSIDE

PT - PRESSURE TREATED

WR - WATER RESISTANT PROJECT SPECIFIC


ALUM - ALUMINUM CONC - CONCRETE CL. - CLEAR ANODIZED

ANOD FD - FLOOR DRAIN

GWB - GYPSUM WALL BOARD HM - HOLLOW METAL PSF - PRESSED STEEL FRAME

RD - ROOF DRAIN ST.ST. - STEEL STUDS

O ISSUED FOR TENDER 04 MAY 2017 O _ ISSUED FOR PERMIT date

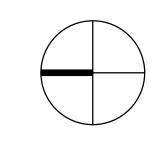



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(613) 238-6595

détail no. feuille no.

detail no.

sheet no.

M-CON PHASE 2 & 4 **EXTENSIONS**


2640 CARP RD. OTTAWA, ON KOA 1LO

drawn by dessiné par			A.H	project no. no. du projet		1712
date				scale		
	23	MARCH	2017		as	noted

PHASE 4 BUILDING SECTIONS

sheet no.
no. de la feuille A301

2 PHASE 4 - BUILDING SECTION A301 SCALE 1/8" = 1'-0"

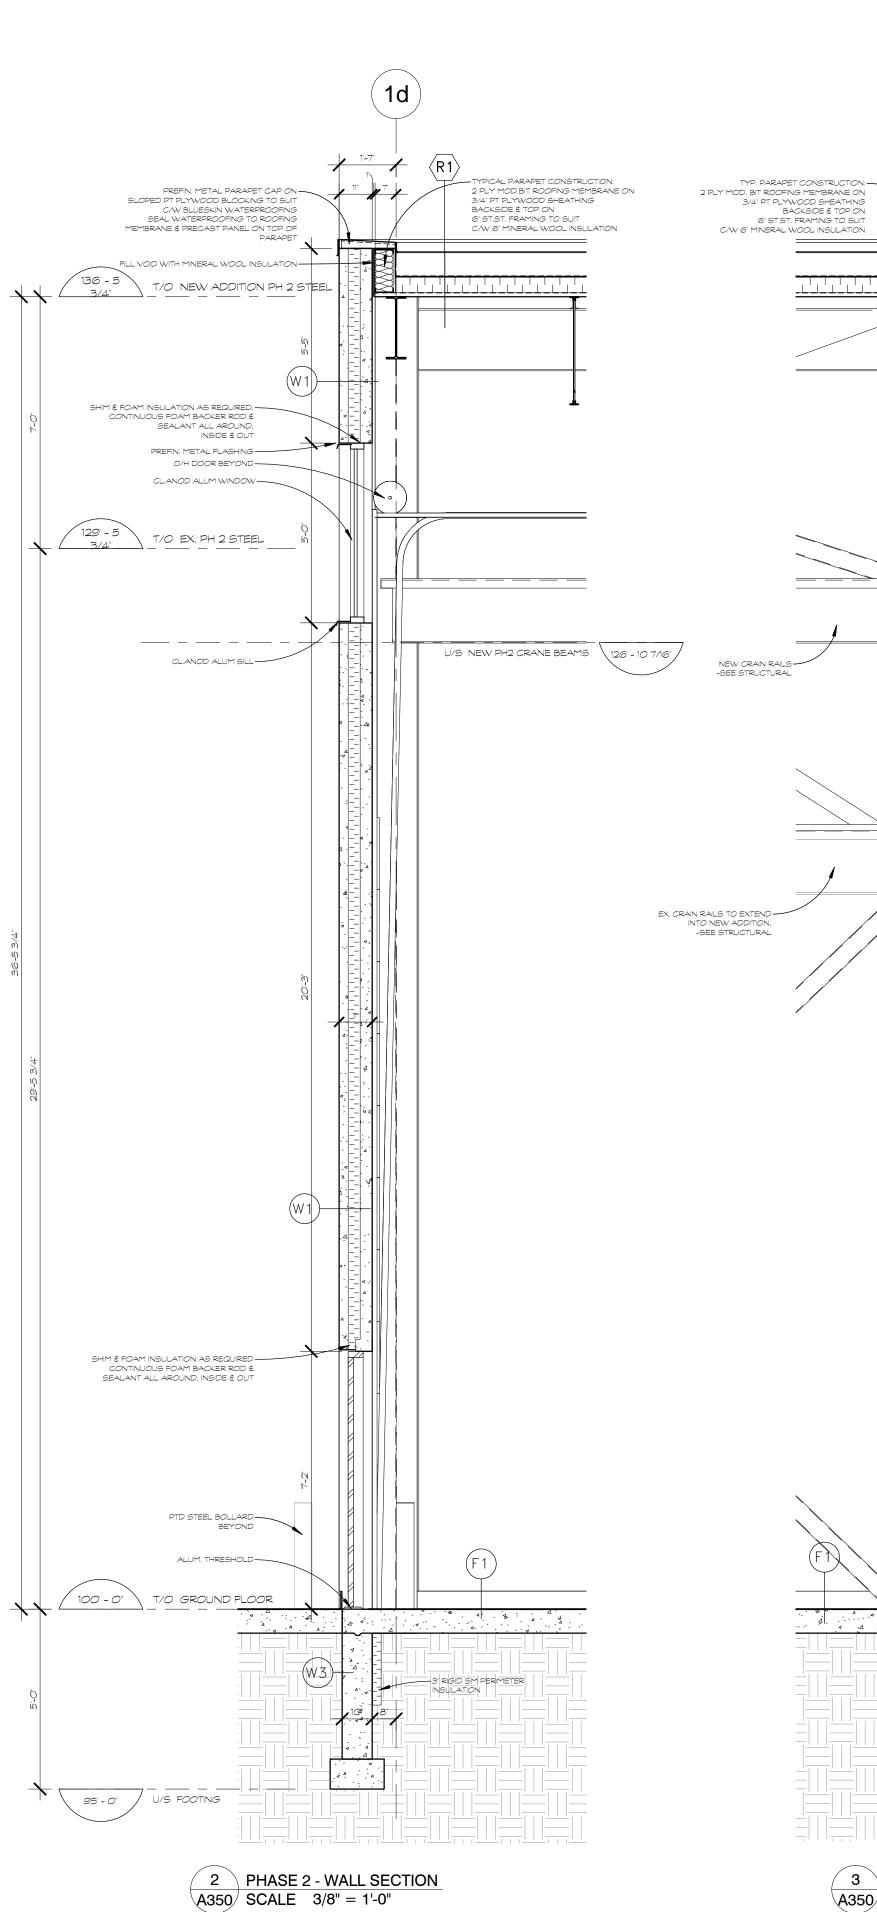

TYPICAL WALL, PARTITION, FLOOR & ROOF CONSTRUCTIONS

TYPICAL EXTERIOR WALL CONSTRUCTIONS

WI PRECAST CONCRETE SANDWICH PANEL WALL (11 11" PRECAST CONCRETE SLAB C/W INSULATED CORE (R22.8) W2 EXTERIOR WALL W/SIDING (11 1/8") 11/2" PREFIN. METAL SIDING PANELS ON

3" GALV. HORIZONTAL Z-BAR FURRING C/W 3" RIGID INSULATION SHEATHING (R10) ALL JOINTS, PERIMETER & PENETRATIONS TAPED & SEALED ON

4" GALV. ST.ST. FRAMING @ 16" O/C C/W MIN. 4" MINERAL WOOL INSULATION (R15) ON 2" GALV. HORIZONTAL Z-BAR FURRING ON

5/8" INTERIOR PREFIN. METAL LINER PANEL & VAPOUR BARRIER W3 FOUNDATION WALLS

REINFORCED CONCRETE AS PER STRUCTURAL DWGS. BELOW GRADE

3" RIG. SM. INSULATION, ADHERED TO INTERIOR PERIMETER FROM U/S FLOOR SLAB TO 2'-0" BELOW FINISHED GRADE

TYPICAL FLOOR CONSTRUCTIONS

$\underline{\mathsf{F1}}$ CONCRETE SLAB REINFORCED POURED CONCRETE SLAB ON GRADE ,

HARDENED -SEE STRUCTURAL


TYPICAL ROOF CONSTRUCTIONS

R1 NEW ROOF (7") 2-PLY MOD. BIT ROOFING SYSTEM ON 5" RIGID POLYISOCYANURATE ROOFING INSULATION ON KRAFT PAPER VAPOUR RETARDER ON

GALV. METAL DECK ON STEEL JOISTS - SEE STRUCTURAL

— PREFIN. METAL PARAPET CAP ON SLOPED PT PLYWOOD BLOCKING TO SUIT C/W BLUESKIN WATERPROOFING MEMBRANE

1. ALL CONTRACTORS SHALL READ AND COMPLY WITH SB-10 PROJECT INFORMATION DETAILED FORMS IDENTIFIED IN THE LIST OF CONTRACT DOCUMENTS ON DRAWING AO

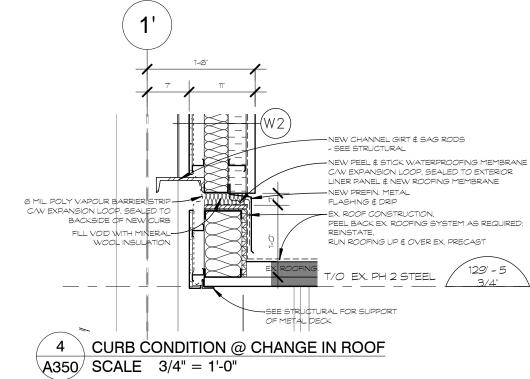

NOTES:

Contractor shall check and verify all dimensions on site and report any discrepancies to the Architect before proceeding.

GENERAL LEGEND

A.F.F. - ABOVE FINISHED FLOOR BF - BARRIER FREE B/S - BOTH SIDES

CJ - CONTROL JOINT C/W - COMPLETE WITH D/F/H - DOOR/FRAME/HARDWARE

EQ - EQUAL

EX - EXISTING

F.R.R. - FIRE RESISTANCE RATING

N.I.C. - NOT IN CONTRACT

N.T.S. - NOT TO SCALE

O/C - ON CENTRES - OVERHEAD

PTD - PAINTED

- PRESSURE TREATED U/C - UNDER COUNTER

- UNLESS NOTED OTHERWISE

U/S - UNDERSIDE

WR - WATER RESISTANT

PROJECT SPECIFIC ALUM - ALUMINUM CONC - CONCRETE


- CLEAR ANODIZED

ANOD FD - FLOOR DRAIN

GWB - GYPSUM WALL BOARD HM - HOLLOW METAL PSF - PRESSED STEEL FRAME

RD - ROOF DRAIN ST.ST. - STEEL STUDS

ISSUED FOR PERMIT date

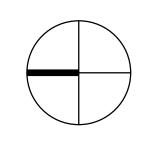



O ASSOC

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KWC ARCHITECTS INC.

detail no. détail no.

sheet no.

drawing / dessin

M-CON PHASE 2 & 4 **EXTENSIONS**

2640 CARP RD. OTTAWA, ON KOA 1LO

feuille no.

designed by conçu par				approved by approuvé par		
drawn by dessiné par			A. H	project no. no. du projet		1712
date				scale		
	23	MARCH	2017		as	noted


PHASE 2 WALL SECTIONS


sheet no.
no. de la feuille A350

95'-0" / U/S FOOTING

1 PHASE 2 - WALL SECTION @ O/H DOOR A350 SCALE 3/8" = 1'-0"

1 PHASE 2 - WALL SECTION A351 SCALE 3/8" = 1'-0"

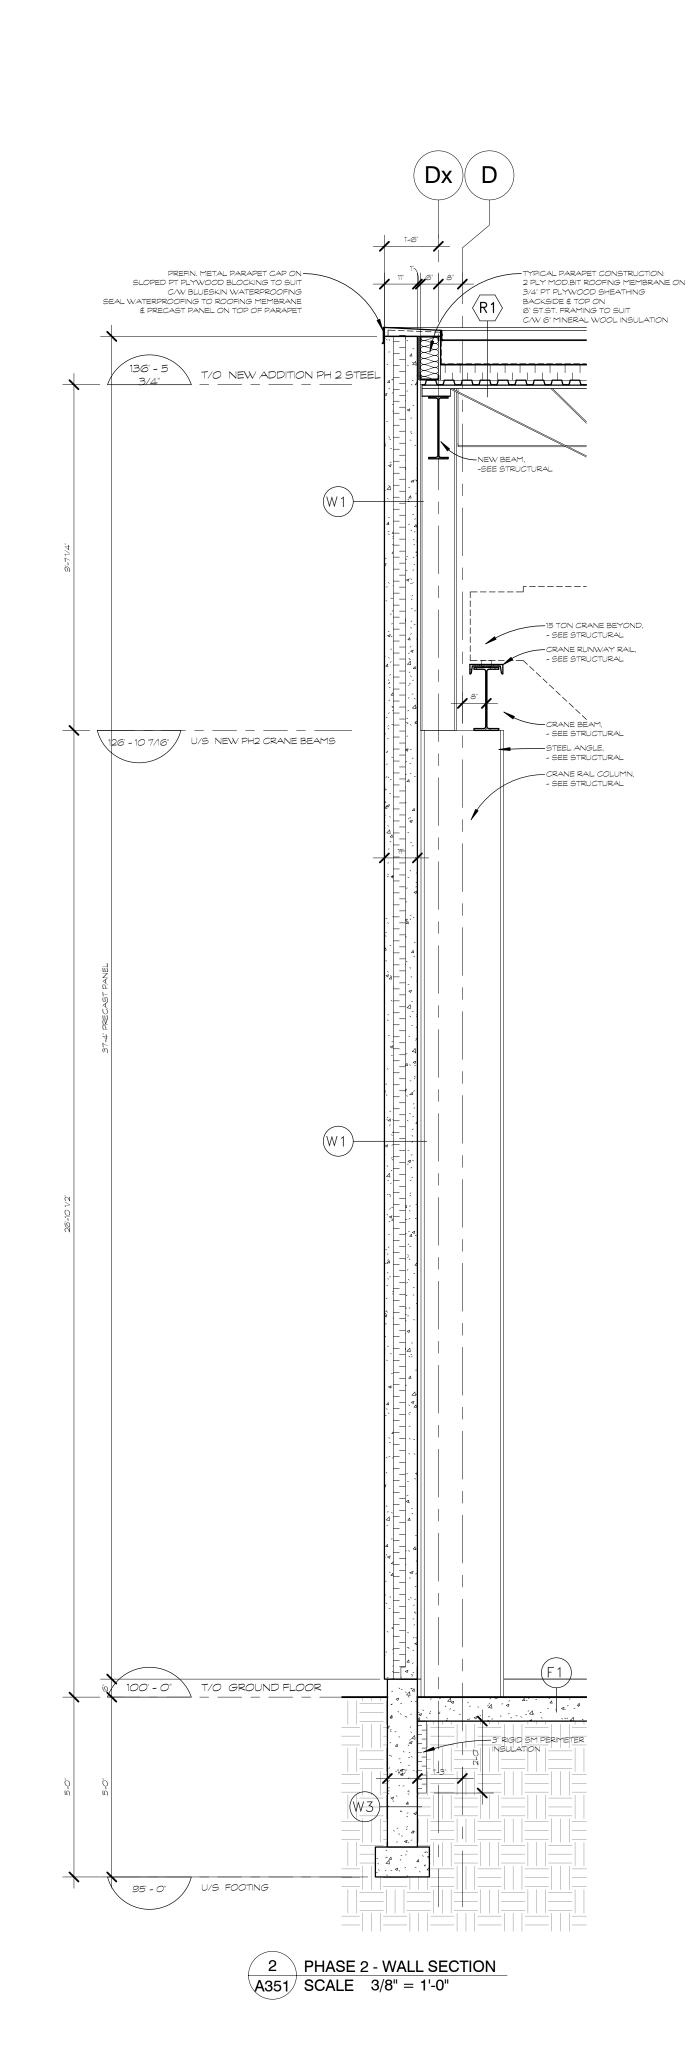

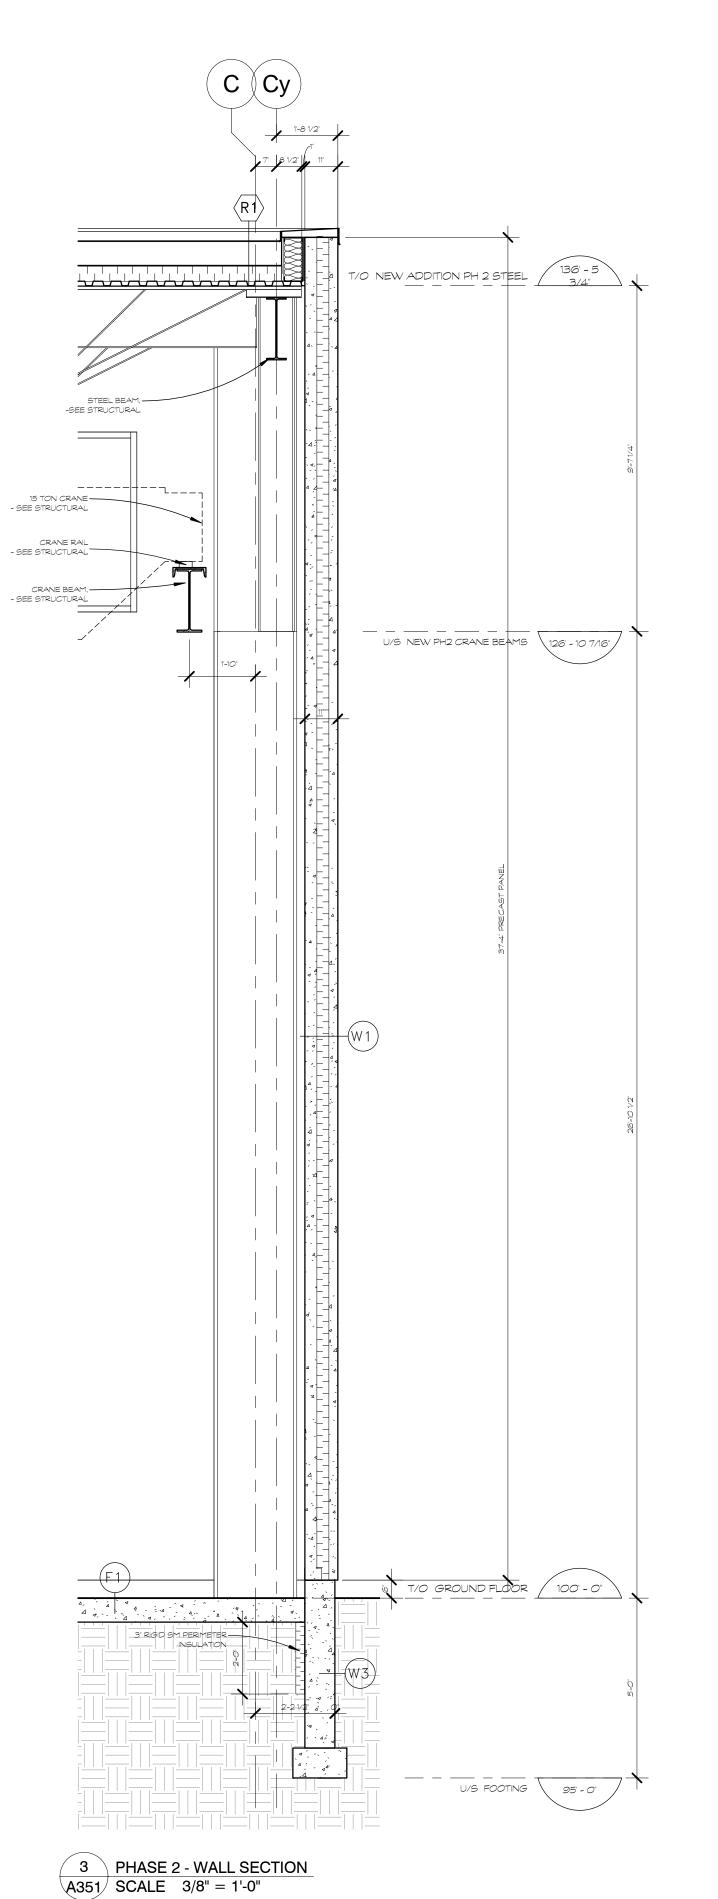

TYPICAL WALL, PARTITION, FLOOR

<u>& ROOF CONSTRUCTIONS</u>

WI PRECAST CONCRETE SANDWICH PANEL WALL (11 11" PRECAST CONCRETE SLAB C/W INSULATED CORE (R22.8) W2 EXTERIOR WALL W/SIDING (11 1/8")

TYPICAL EXTERIOR WALL CONSTRUCTIONS

11/2" PREFIN. METAL SIDING PANELS ON 3" GALV. HORIZONTAL Z-BAR FURRING C/W 3" RIGID INSULATION SHEATHING (R10)

4" GALV. ST.ST. FRAMING @ 16" O/C C/W MIN. 4" MINERAL WOOL INSULATION (R15) ON 2" GALV. HORIZONTAL Z-BAR FURRING ON

ALL JOINTS, PERIMETER & PENETRATIONS TAPED & SEALED ON

5/8" INTERIOR PREFIN. METAL LINER PANEL & VAPOUR BARRIER W3 FOUNDATION WALLS

REINFORCED CONCRETE AS PER STRUCTURAL DWGS.

3" RIG. SM. INSULATION, ADHERED TO INTERIOR PERIMETER FROM U/S FLOOR SLAB TO 2'-O" BELOW FINISHED GRADE

TYPICAL FLOOR CONSTRUCTIONS

<u>F1 CONCRETE SLAB</u> REINFORCED POURED CONCRETE SLAB ON GRADE , HARDENED

-SEE STRUCTURAL

TYPICAL ROOF CONSTRUCTIONS

R1 NEW ROOF (7") 2-PLY MOD. BIT ROOFING SYSTEM ON 5" RIGID POLYISOCYANURATE ROOFING INSULATION ON KRAFT PAPER VAPOUR RETARDER ON

STEEL JOISTS - SEE STRUCTURAL

GALV. METAL DECK ON

1. ALL CONTRACTORS SHALL READ AND COMPLY WITH SB-10 PROJECT INFORMATION DETAILED FORMS IDENTIFIED IN THE LIST OF CONTRACT DOCUMENTS ON DRAWING AO

NOTES:

Contractor shall check and verify all dimensions on site and report any discrepancies to the Architect before proceeding.

GENERAL LEGEND

A.F.F. - ABOVE FINISHED FLOOR - BARRIER FREE - BOTH SIDES

- CONTROL JOINT C/W - COMPLETE WITH

D/F/H - DOOR/FRAME/HARDWARE EQ - EQUAL

EX - EXISTING F.R.R. - FIRE RESISTANCE RATING

N.I.C. - NOT IN CONTRACT N.T.S. - NOT TO SCALE

O/C - ON CENTRES O/H - OVERHEAD

PTD - PAINTED PT - PRESSURE TREATED

U/C - UNDER COUNTER U/N - UNLESS NOTED

OTHERWISE - UNDERSIDE WR - WATER RESISTANT

PROJECT SPECIFIC

ALUM - ALUMINUM CONC - CONCRETE


CL. - CLEAR ANODIZED ANOD

FD - FLOOR DRAIN GWB - GYPSUM WALL BOARD

HM - HOLLOW METAL PSF - PRESSED STEEL FRAME

RD - ROOF DRAIN ST.ST. - STEEL STUDS

ISSUED FOR PERMIT

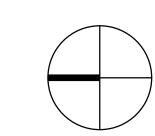

NO ASSOC

date

383 Parkdale Avenue, Suite 201 Ottawa Ontario Canada K1Y 4R4

KWC ARCHITECTS INC.

detail no. sheet no.

détail no.

M-CON PHASE 2 & 4 **EXTENSIONS**

2640 CARP RD. OTTAWA, ON K0A 1L0


23 MARCH 2017

drawing / dessin

PHASE 2 WALL SECTIONS

sheet no.
no. de la feuille A351

SHEET SIZE: ARCH D (24"x36")

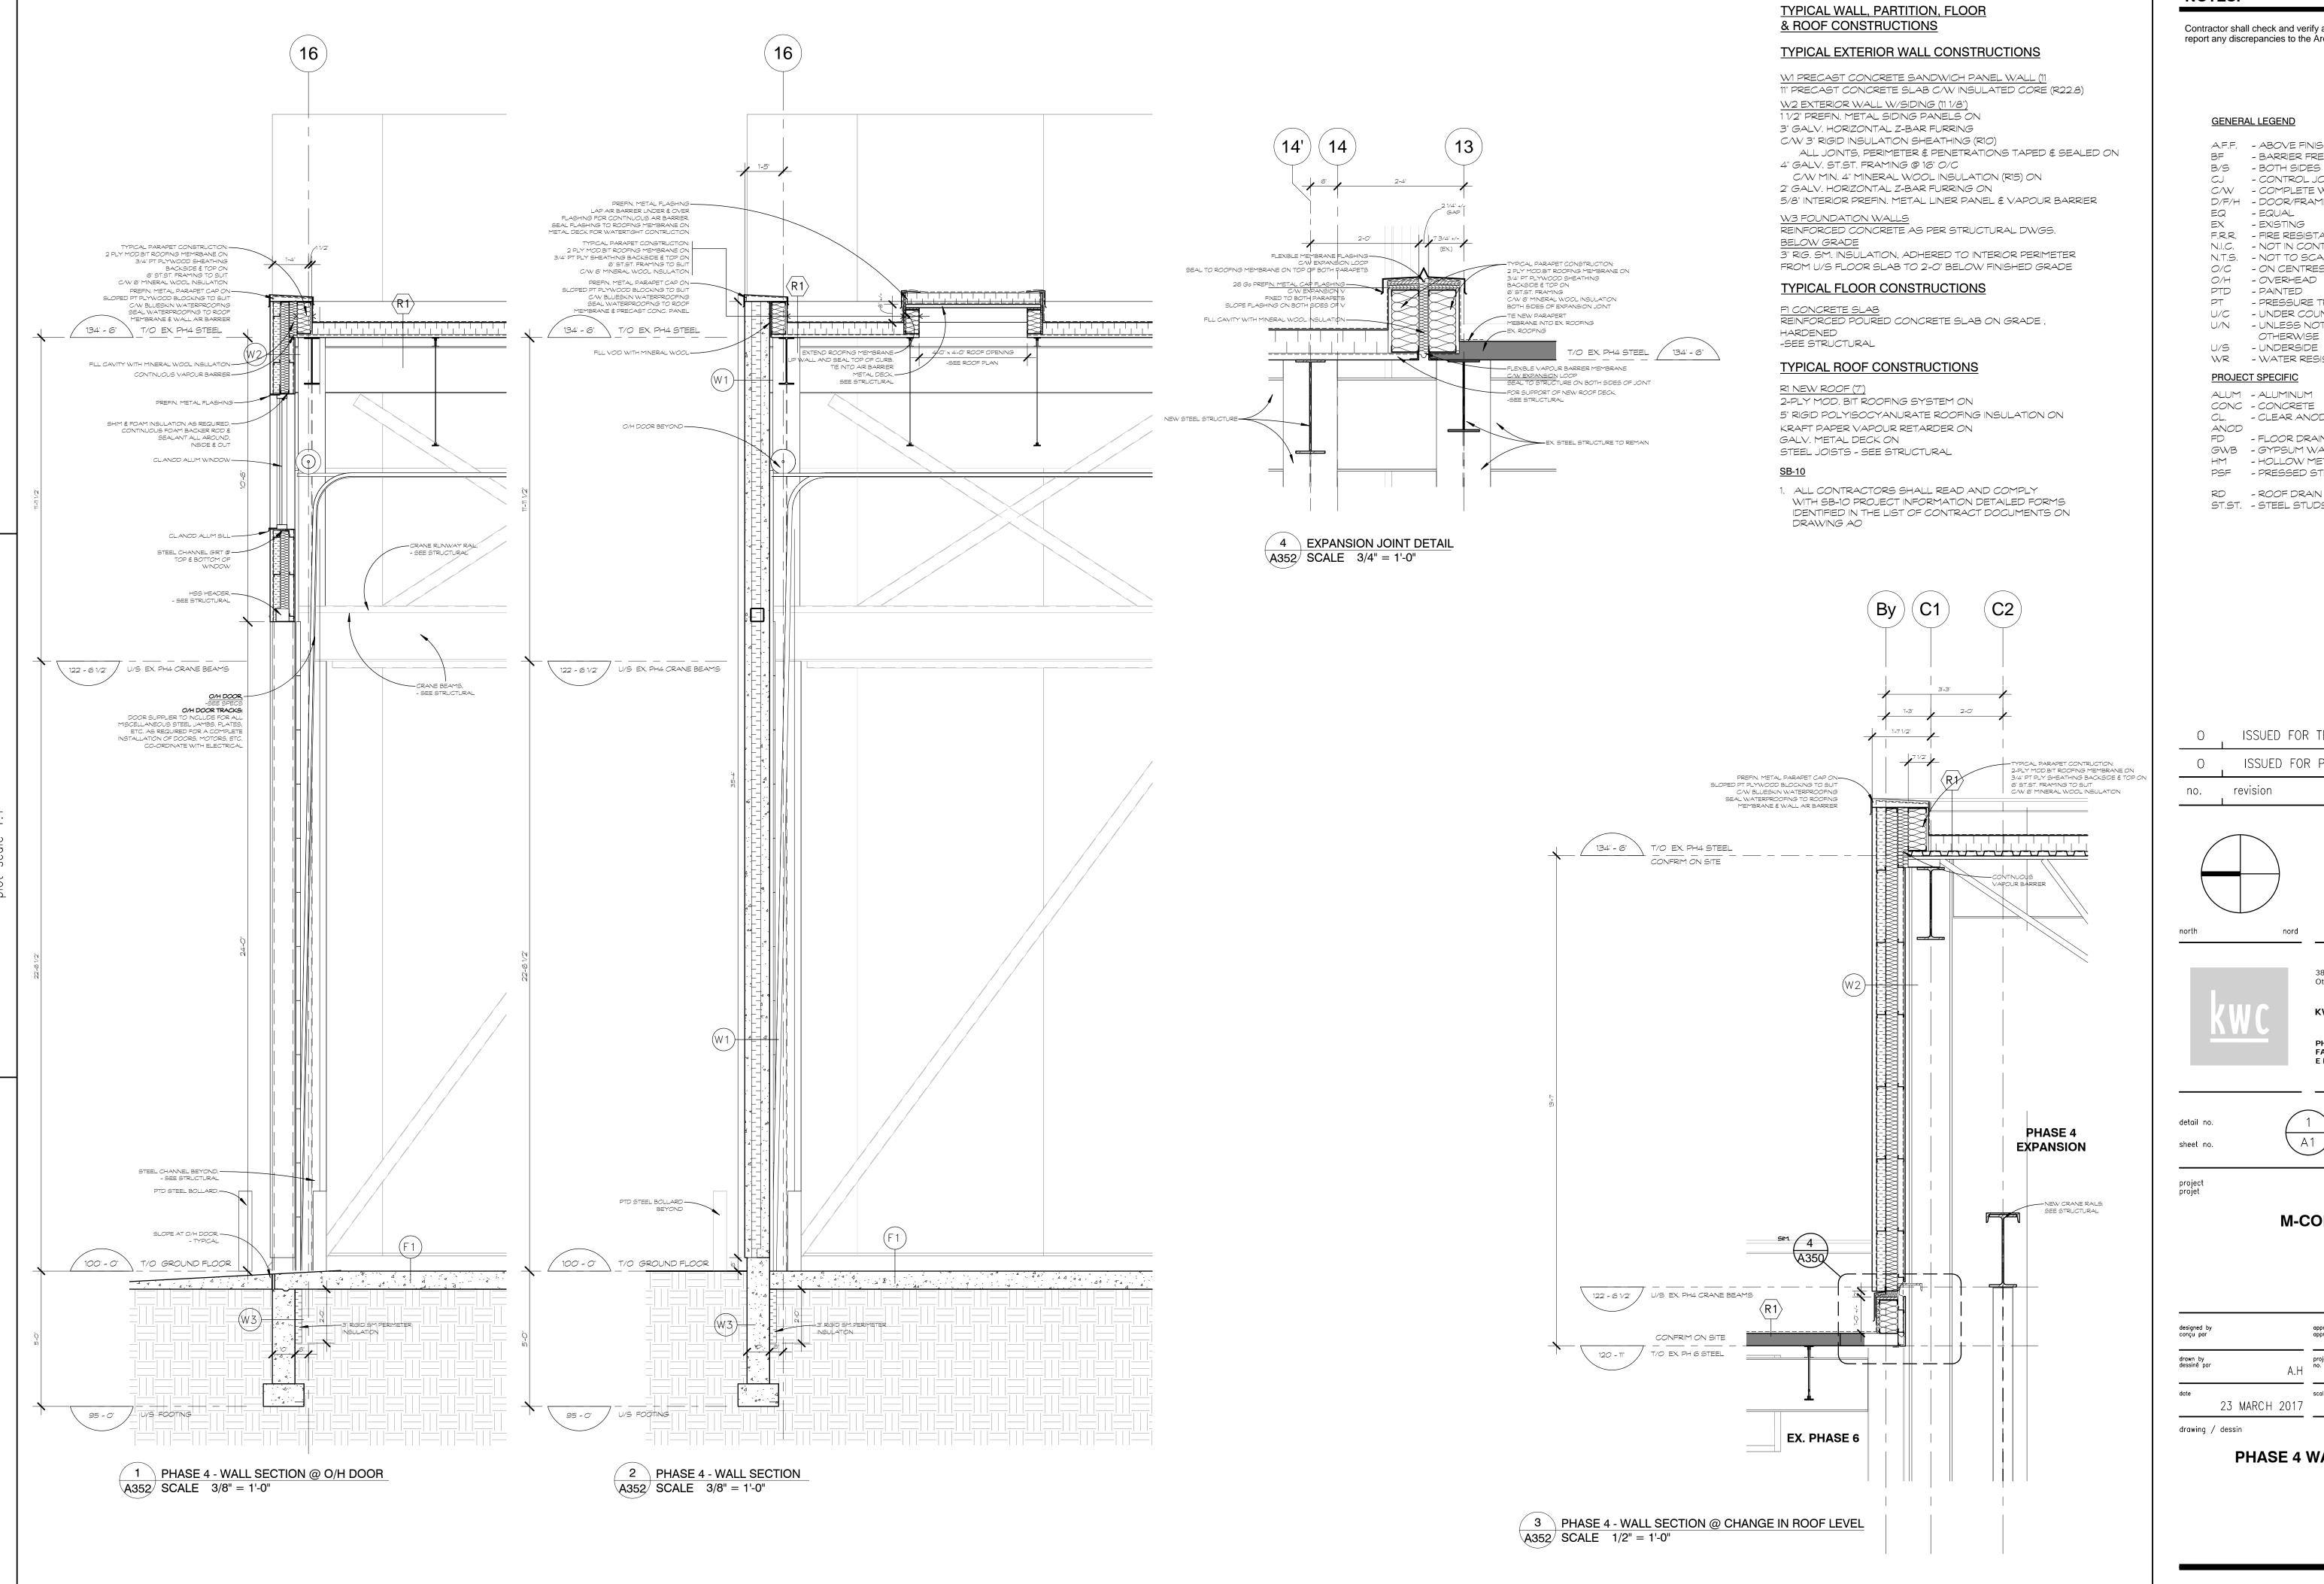

Contractor shall check and verify all dimensions on site and report any discrepancies to the Architect before proceeding.

GENERAL LEGEND

A.F.F. - ABOVE FINISHED FLOOR BF - BARRIER FREE B/S - BOTH SIDES - CONTROL JOINT

C/W - COMPLETE WITH D/F/H - DOOR/FRAME/HARDWARE EQ - EQUAL EX - EXISTING

F.R.R. - FIRE RESISTANCE RATING N.I.C. - NOT IN CONTRACT N.T.S. - NOT TO SCALE O/C - ON CENTRES

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U/S - UNDERSIDE WR - WATER RESISTANT

OTHERWISE

PROJECT SPECIFIC


ALUM - ALUMINUM CONC - CONCRETE CL. - CLEAR ANODIZED

ANOD FD - FLOOR DRAIN GWB - GYPSUM WALL BOARD HM - HOLLOW METAL

PSF - PRESSED STEEL FRAME

RD - ROOF DRAIN ST.ST. - STEEL STUDS

0	ISSUED FOR TENDER	04 MAY 2017
0	ISSUED FOR PERMIT	23 MAR 2017
no.	revision	date

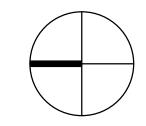



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KWC ARCHITECTS INC.

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détail no.

feuille no.

M-CON PHASE 2 & 4 **EXTENSIONS**

2640 CARP RD. OTTAWA, ON KOA 1LO

designed by conçu par				approved by approuvé par		
drawn by dessiné par			A .H	project no. no. du projet		1712
date				scale		
	23	MARCH	2017		as	noted

PHASE 4 WALL SECTIONS