
BRY-AIN HOLDINGS LTD. EQUIPMENT REPAIR GARAGE 2688 CARP ROAD, CARP, ONTARIO

ISSUED FOR BUILDING PERMIT

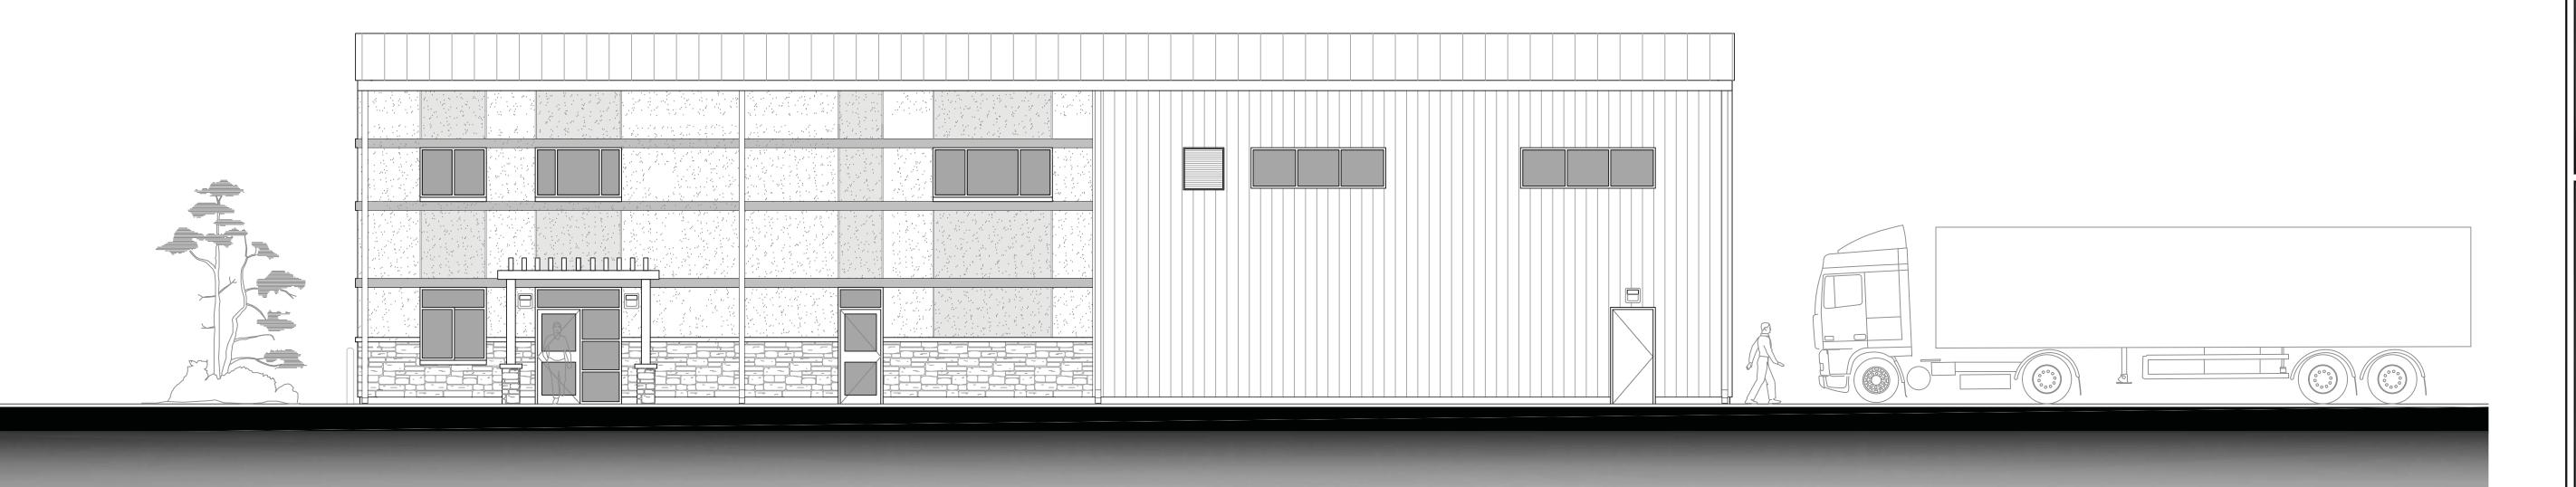



PROJECT TEAM					
DESIGN BUILDER	ARGUE CONSTRUCTION LTD.				
	2900 CARP ROAD CARP, ONTARIO, KOA 1L0 TEL.: (613) 831-7044 FAX.: (613) 831-6344				
ARCHITECT	A+ ARCHITECTURE INC.				
	555 LEGGET DRIVE, TOWER A, SUITE 304 KANATA, ONTARIO, K2K 2X3 E-mail: info@aplus-arch.com TEL.: (613) 699-6860 FAX.: (613) 800-2204				
STRUCTURAL CONSULTANT	CLELAND JARDINE ENGINEERING LTD.				
	580 TERRY FOX DRIVE, SUITE 200 KANATA, ONTARIO, K2L 4B9 E-mail: mail@clelandjardine.com TEL.: (613) 591-1533 FAX.: (613) 591-1703				
CIVIL ENGINEERING	D. B. GRAY ENGINEERING INC.				
CONSULTANT	700 LONG POINT CIRCLE, OTTAWA, ONTARIO, K1T 4E9 E-mail: dbgray@rogers.com TEL.: (613) 425-8044				
MECHANICAL &	M&E ENGINEERING				
ELECTRICAL CONSULTANT	205 KINCARDINE DRIVE KANATA, ONTARIO, K2V LC5 TEL.: (613) 836-3420 FAX.: (613) 836-5957				

M-2 GROUND AND SECOND FLOOR HVAC A0.1 OBC MATRIX LAYOUTS OBC REVIEW SUMMARY M-3 PLUMBING SPECIFICATIONS A1.0 SITE PLAN M-4 HVAC SPECIFICATIONS A2.0 FOUNDATION AND ROOF PLANS A2.1 FIRST AND SECOND FLOOR PLANS, WALL ELECTRICAL **ASSEMBLIES** E-1 SITE PLAN ELECTRICAL LAYOUT A2.2 FIRST AND SECOND FLOOR REFLECTED E-2 GROUND AND SECOND FLOOR POWER **CEILING PLANS** LAYOUTS A3.0 EXTERIOR ELEVATIONS E-3 GROUND AND SECOND FLOOR A4.0 BUILDING SECTIONS LIGHTING LAYOUTS A5.0 WALL SECTIONS E-4 ELECTRICAL SPECIFICATIONS A5.1 DETAILS A6.0 WASHROOM ENLARGED PLANS, ELEVATIONS AND DETAILS C-1 SITE SERVICING AND PART GRADING A6.1 STAIR ENLARGED PLANS AND SECTION A6.2 KITCHEN ENLARGED PLAN, ELEVATION, C-2 GRADING PLAN AND EROSION AND AND TYPICAL STAIR DETAILS SEDIMENT CONTROL PLAN A7.0 SCHEDULES A7.1 DOOR HARDWARE SCHEDULES C-3 NOTES AND DETAILS C-4 DRAINAGE PLAN (INFILTRATION TRENCHES) STRUCTURAL S000 GENERAL NOTES AND DETAILS LANDSCAPING \$100 PLANS AND SECTIONS L1.0 LANDSCAPE PLAN

MECHANICAL


M-1 GROUND AND SECOND FLOOR PLUMBING LAYOUTS

DRAWING LIST

A0.0 COVER SHEET

DRAWING LIST


ARCHITECTURAL

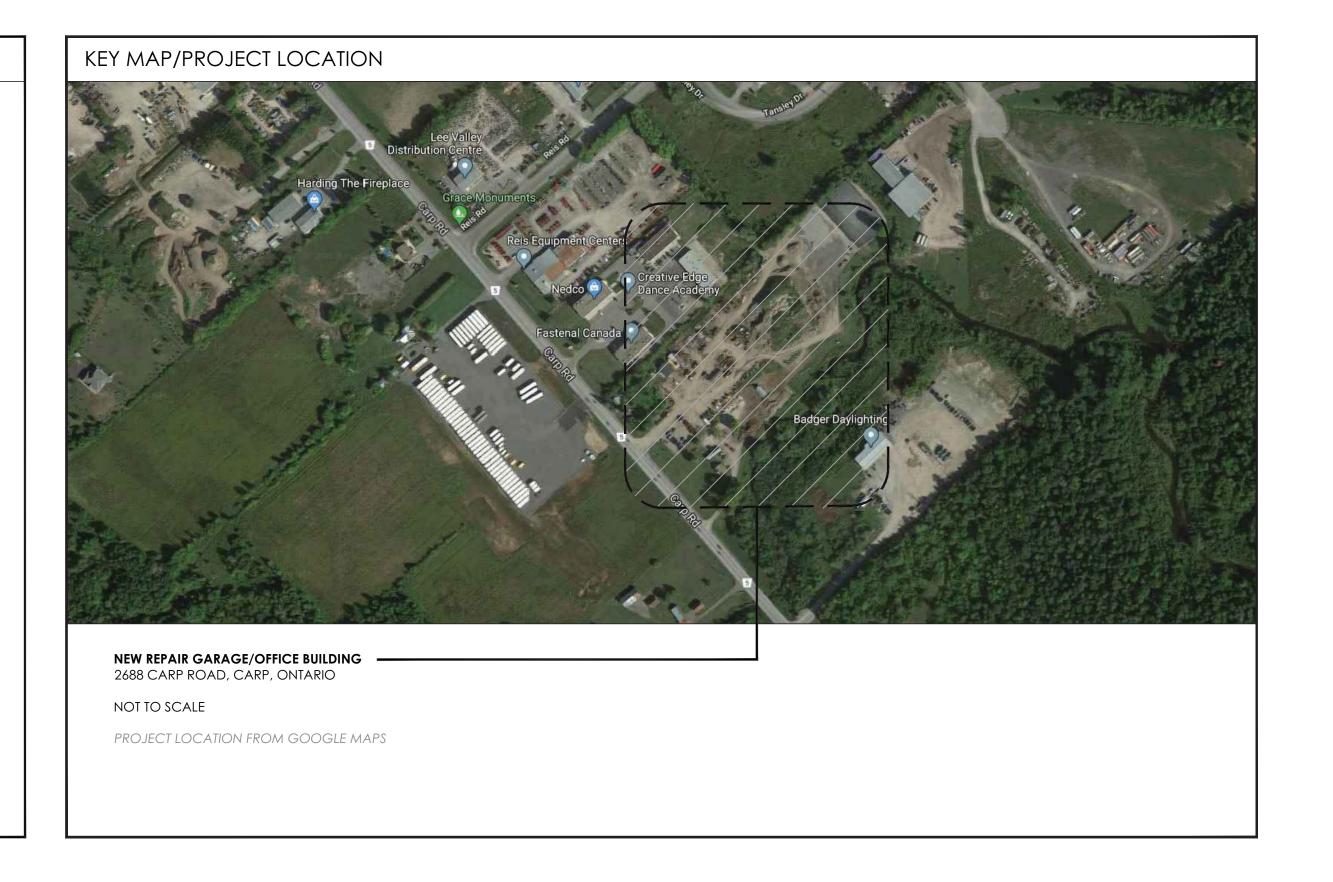




GENERAL NOTES

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PROJECT

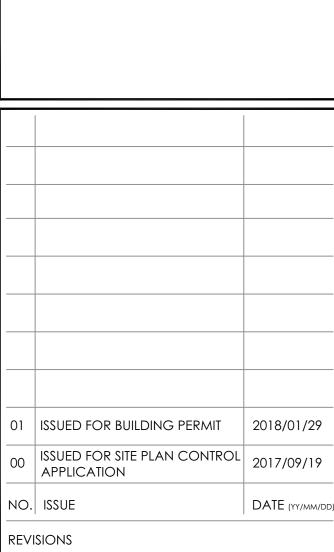
EQUIPMENT REPAIR GARAGE

2688 CARP ROAD KANATA, ON KOA 1LO

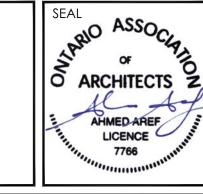DRAWING TITLE

COVER SHEET OBC MATRIX DRAWING LIST

DRAWN BY C.M. | DRAWING NO. REVIEWED BY START DATE 2017/06/05 PROJECT NO. 17004 REVISION NO.

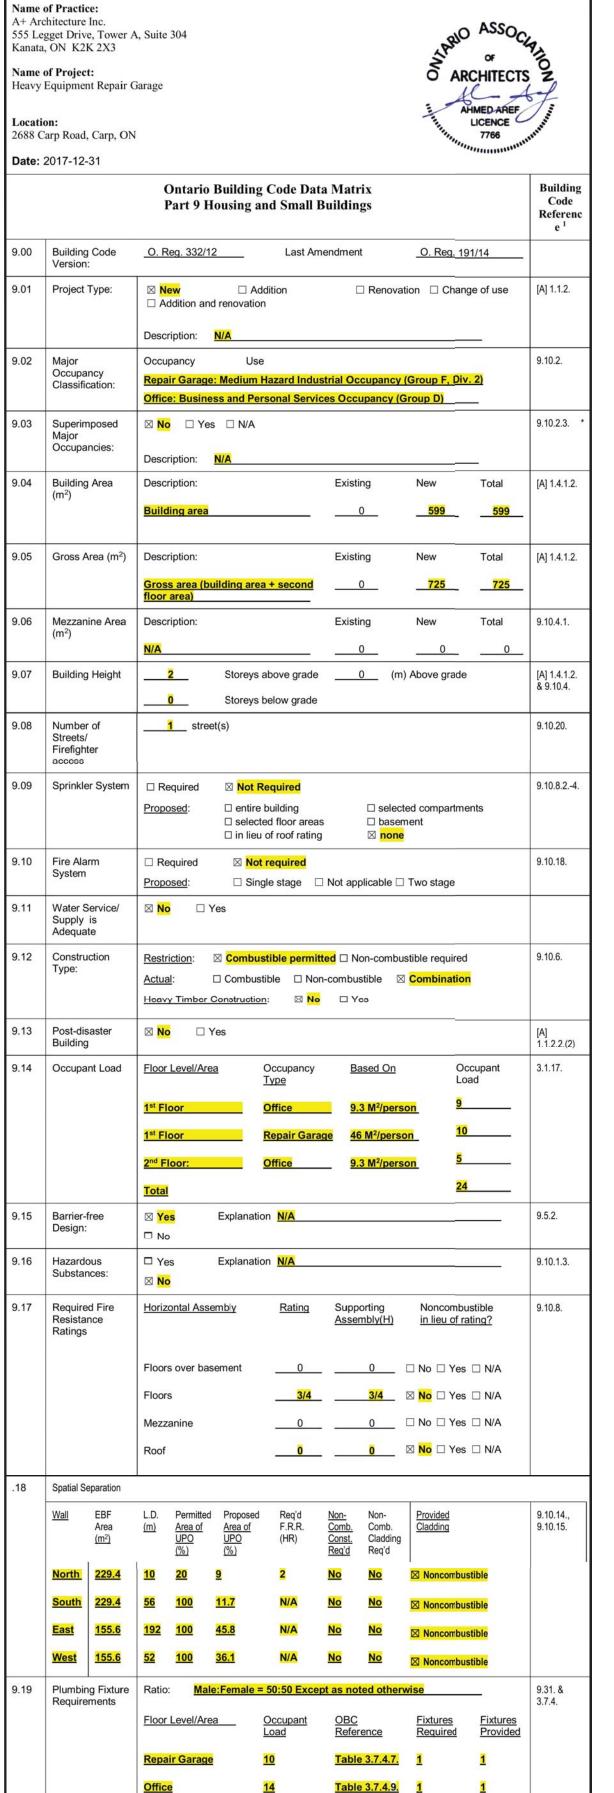

ONTARIO BUILDING CODE (2012) REVIEW SUMMARY

General Description:

- A two-storey building comprising of a truck repair garage on the ground floor level and a two-storey office.
- Construction assemblies: pre-engineered, prefabricated metal building, complete with metal siding and roof. Wood stud framing, wood sheathing and structural wood joist floor for the two-storey office component of the building.
- Occupancy: medium-hazard industrial occupancy (repair garage) + business and personal services occupancy (office).

Building Area: 599 Sq. M. 2 Storeys Building Height: Underground Levels: 0

Application of Division B, Parts 9

Part 9 of Division B applies to this building, since the building height is less than 3 storeys, the building area does not exceed 600 sq.m., and the building is used for Group (F2) -Medium Hazard Industrial and Group (D) - Business and Personal Services occupancies. [Reference: Div. A, Part 1, 1.1.2.4.].

Classification of Buildings or Parts of Buildings by Major Occupancy

- Group (D) Business and Personal Services Occupancy: offices
- Group (F), Div. (2) Medium Hazard Industrial Occupancy: repair garage

Occupant Load Calculation

- Group (D) Business and Personal Services Occupancy: offices
- Waiting Room (01): 5 persons (based on design)
- Dispatcher's Office (02): 13 Sq.M./9.3 = 1.4 persons
- General Office (03): 18.5 Sq. M./9.3 = 2 persons
- Stock Room (05): 15 Sq. M./46 = 0.3 persons Mech./Elec. Room (08): N/A
- o Second Floor Level
- President Office (10): 18 Sq.M./9.3 = 1.9 persons
- Office (11): 14.5 Sq.M./9.3 = 1.6 persons
- Office (12): 15 Sq.M./9.3 = 1.6 persons
- Lunch Room (15): N/A (no additional occupants)
- Total occupants in offices: 14 persons
- Group (F), Div. (2) Medium Hazard Industrial Occupancy: repair garage
- 456 Sq.M./46 = 10 persons
- Total occupants in repair garage: 10 persons

Fire Separation for Exits

Exit stair shall be protected from the adjacent floor areas by a fire separation having a fire resistance rating not less than that required for the floor assemblies above/below the floor area. [Reference: 9.9.4.2.(1)].

Only one egress doorway is required from the second floor level, since the second floor area does not exceed 200 Sq.M. and the maximum travel distance to an egress/exit doorway does not exceed 25M. [Reference: 9.9.7.4.(1)].

Number of Required Exits

Only one exit is permitted on the second floor level, since the building is 2 storeys in building height, the building area and travel distance requirements conform to Article 9.9.7.4., and the total occupant load does not exceed 60 persons. [Reference: 9.9.8.2.(2)].

The maximum travel distance to an exit in the repair garage is 30M. [Reference:

Fire Resistance Ratings for Floors and Roofs

Floor assemblies are required to be constructed as fire separation with 45 mins. F.R.R. No fire resistance rating is required for the roof. [Reference: Table 9.10.8.1.].

Separation of Repair Garages

No fire separation is required between the repair garage and the office (ancillary spaces) serving the repair garage. [Reference: 9.10.9.17.(2)].

The part of the second floor that does not terminate at exterior walls shall terminate at fire separation having a F.R.R. of 45 min. [Reference: 9.10.12.1.(1)].

Separation of Service Rooms

No fire separation is required between the Mech./Elec. Room and the remainder of the building, since the equipment located in the room serves only one suite. [Reference: 9.10.10.4.(2)(a)].

Separation of Storage Rooms

No fire separation is required between the Stock Room and the remainder of the building, since the room is not used for the temporary storage of combustible refuse. [Reference: 9.10.10.6.(1)].

Barrier-Free Design

A barrier-free path of travel is not required to extend to the second floor level since the building is less than 3 storeys in building height and has a building area less than 600 Sq.M. [Reference: 3.8.2.1.(2)(b)].

At least one (1) universal washroom is required in the building since the total number of storeys is 2. [Reference: Table 3.8.2.3A.].

ONTARIO BUILDING CODE (2012) REVIEW SUMMARY (CONT'D)

Plumbing Fixtures

- Office:
 - Required: 1 water closet for each sex. [Reference: Table 3.7.4.7.].
 - Provided: 1 universal washroom and 1 uni-sex washroom. [Reference: 3.7.4.2.(8)].
- Repair Garage:
- Required: 1 water closet for each sex. [Reference: Table 3.7.4.9.]. • Provided: 1 uni-sex washroom. [Reference: 3.7.4.9.(2)(a)].

Energy Efficiency Requirements (Part 12 and SB-10)

Application and Compliance:

Part 12 applies to this building. [Reference: Division A, 1.1.2.1.(2)].

This building is permitted to conform to Division 3 or Division 5 of SB-10, since the building is within the scope of Part 9, and does not contain a residential component. [Reference: SB-10, Division 1, Article 1.1.1.3.(2)) and Note 1 to Table 1.2.1.1. in Division 3].

The "Repair Garage" occupancy is exempt from having to comply with Division 5 of SB-10. [Reference: SB-10, Division 5, 1.1.1.5., and Division 3, Table 1.2.1.1.].

Building Envelope:

With reference to Division 5, Table 1.1.1.2., and considering climatic zone 1 (Kanata with 4520 degree-days below 18°C, from Table 1.2. in SB-1):

- Roof: R-35 continuous Insulation
- Building Walls (above grade): R13 + R15 continuous insulation.
- Building Walls (below grade): R20 continuous insulation.
- Unheated Slab on Grade Floors: R15 for 48"

END OF ONTARIO BUILDING CODE REVIEW SUMMARY



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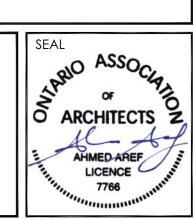


ORIENTATION

NO. ISSUE

REVISIONS

00 ISSUED FOR BUILDING PERMIT



DATE (YY/MM/DE



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BRY-AIN HOLDINGS LTD.

PROJECT

EQUIPMENT REPAIR GARAGE


2688 CARP ROAD KANATA, ON KOA 1LO

DRAWING TITLE

OBC MATRIX OBC REVIEW SUMMARY

C.M. | DRAWING NO. REVIEWED BY A.A. A0.1 START DATE 2017/06/05 PROJECT NO. 17004 REVISION NO.

SHEET SIZE: ARCH E1 24" X 36" (609.6mm X 914.4mm) PLOT DATE: January 29, 2018

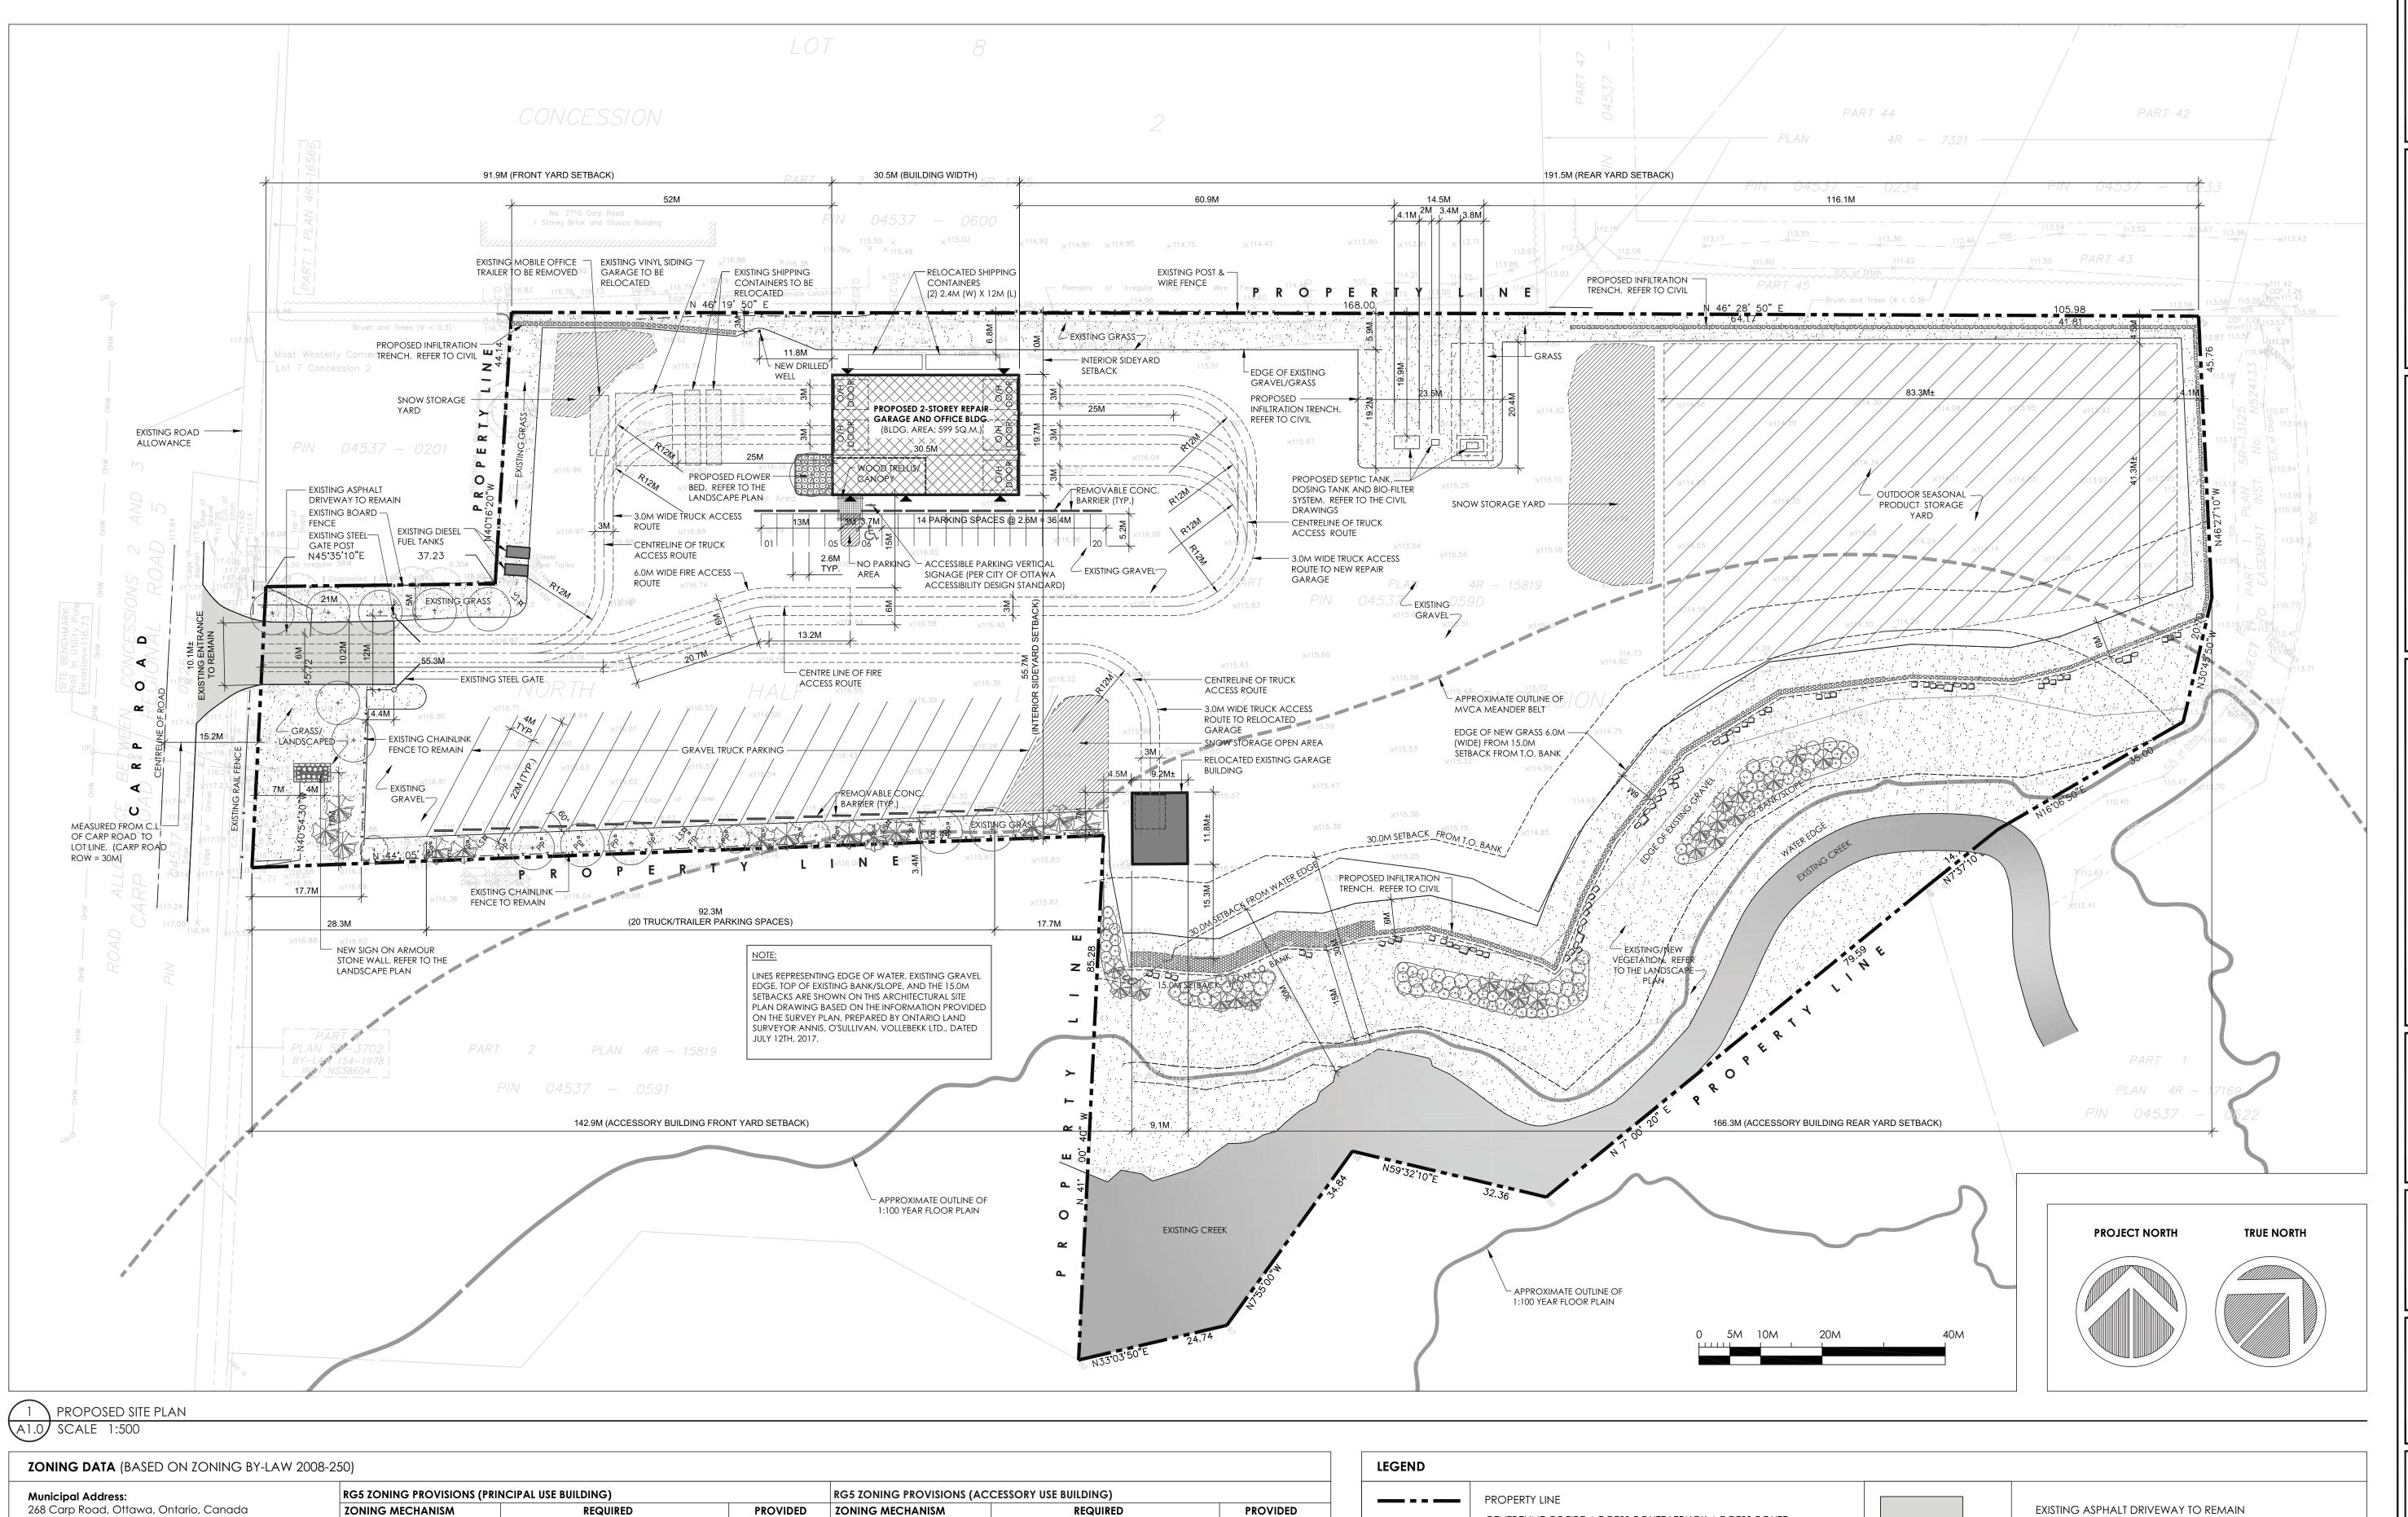

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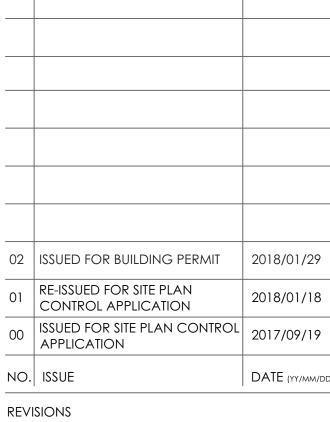
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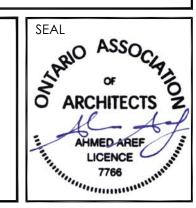
SURVEY PLAN DISCLAIMER

THIS ARCHITECTURAL SITE PLAN DRAWING IS PREPARED BASED ON A SURVEY PLAN PROVIDED TO A+ ARCHITECTURE INC. OF EXISTING LAND FEATURES, INCLUDING BUT NOT LIMITED TO, EXISTING LEGAL BOUNDARIES, LOT LINES, GRADES TOPOGRAPHY, VEGETATION ETC., SHOWN ON THIS DRAWING FOR COORDINATION PURPOSES ONLY AND ARE BASED ON THE SURVEY PLAN PREPARED BY ANNIS, O'SULLIVAN, VOLLEBEKK LTD., ONTARIO LAND SURVEYOR, DATED JULY 12, 2017.

THE AFOREMENTIONED SURVEY PLAN WAS INCORPORATED INTO THE ARCHITECTURAL SITE PLAN DRAWING, AS PROVIDED TO A+ ARCHITECTURE INC., WITH NO ALTERATIONS WHATSOEVER. A+ ARCHITECTURE INC. SHALL NOT BE HELD LIABLE AS TO THE ACCURACY OF THE INFORMATION PROVIDED ON THE SURVEY PLAN.



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BRY-AIN HOLDINGS LTD.

PROJECT

EQUIPMENT REPAIR GARAGE

2688 CARP ROAD KANATA, ON KOA 1LO

DRAWING TITLE

SITE PLAN

DRAWN BY	C.M.	DRAWING NO.	
REVIEWED BY		A 1	
START DATE 201	7/06/05	AI	•
PROJECT NO.	17004	REVISION NO.	_
I KOJECI NO.	1/004	KL VISION NO.	

1 Parking Space



ON THIS DRAWING FOR COORDINATION PURPOSES ONLY. REFER TO THE LANDSCAPE PLAN FOR DETAILS

EXISTING LIGHT STANDARD

Part of Lot 7, Concession 2, Geographic Township of

Rural General Industrial Zone (RG5) - Area D Rural

Legal Description:

Huntley, City of Ottawa

Site Area: 3.199 Ha (31,990 Sq.M.)

• Existing/ Relocated Building: 109 Sq.M.

• Total Buildings Gross Area: 708 Sq.M.

Lot Coverage: (708/31,990) x 100 = 2.2%

• New Building: 599 Sq.M.

• First Floor Area: 599 Sq.M.

• **Total GFA:** 725 Sq.M.


• Second Floor Area: 126 Sq.M.

Zoning Designation:

Building Area:

Gross Floor Area:

DISABLED PARKING SPACES | 1 Parking Space

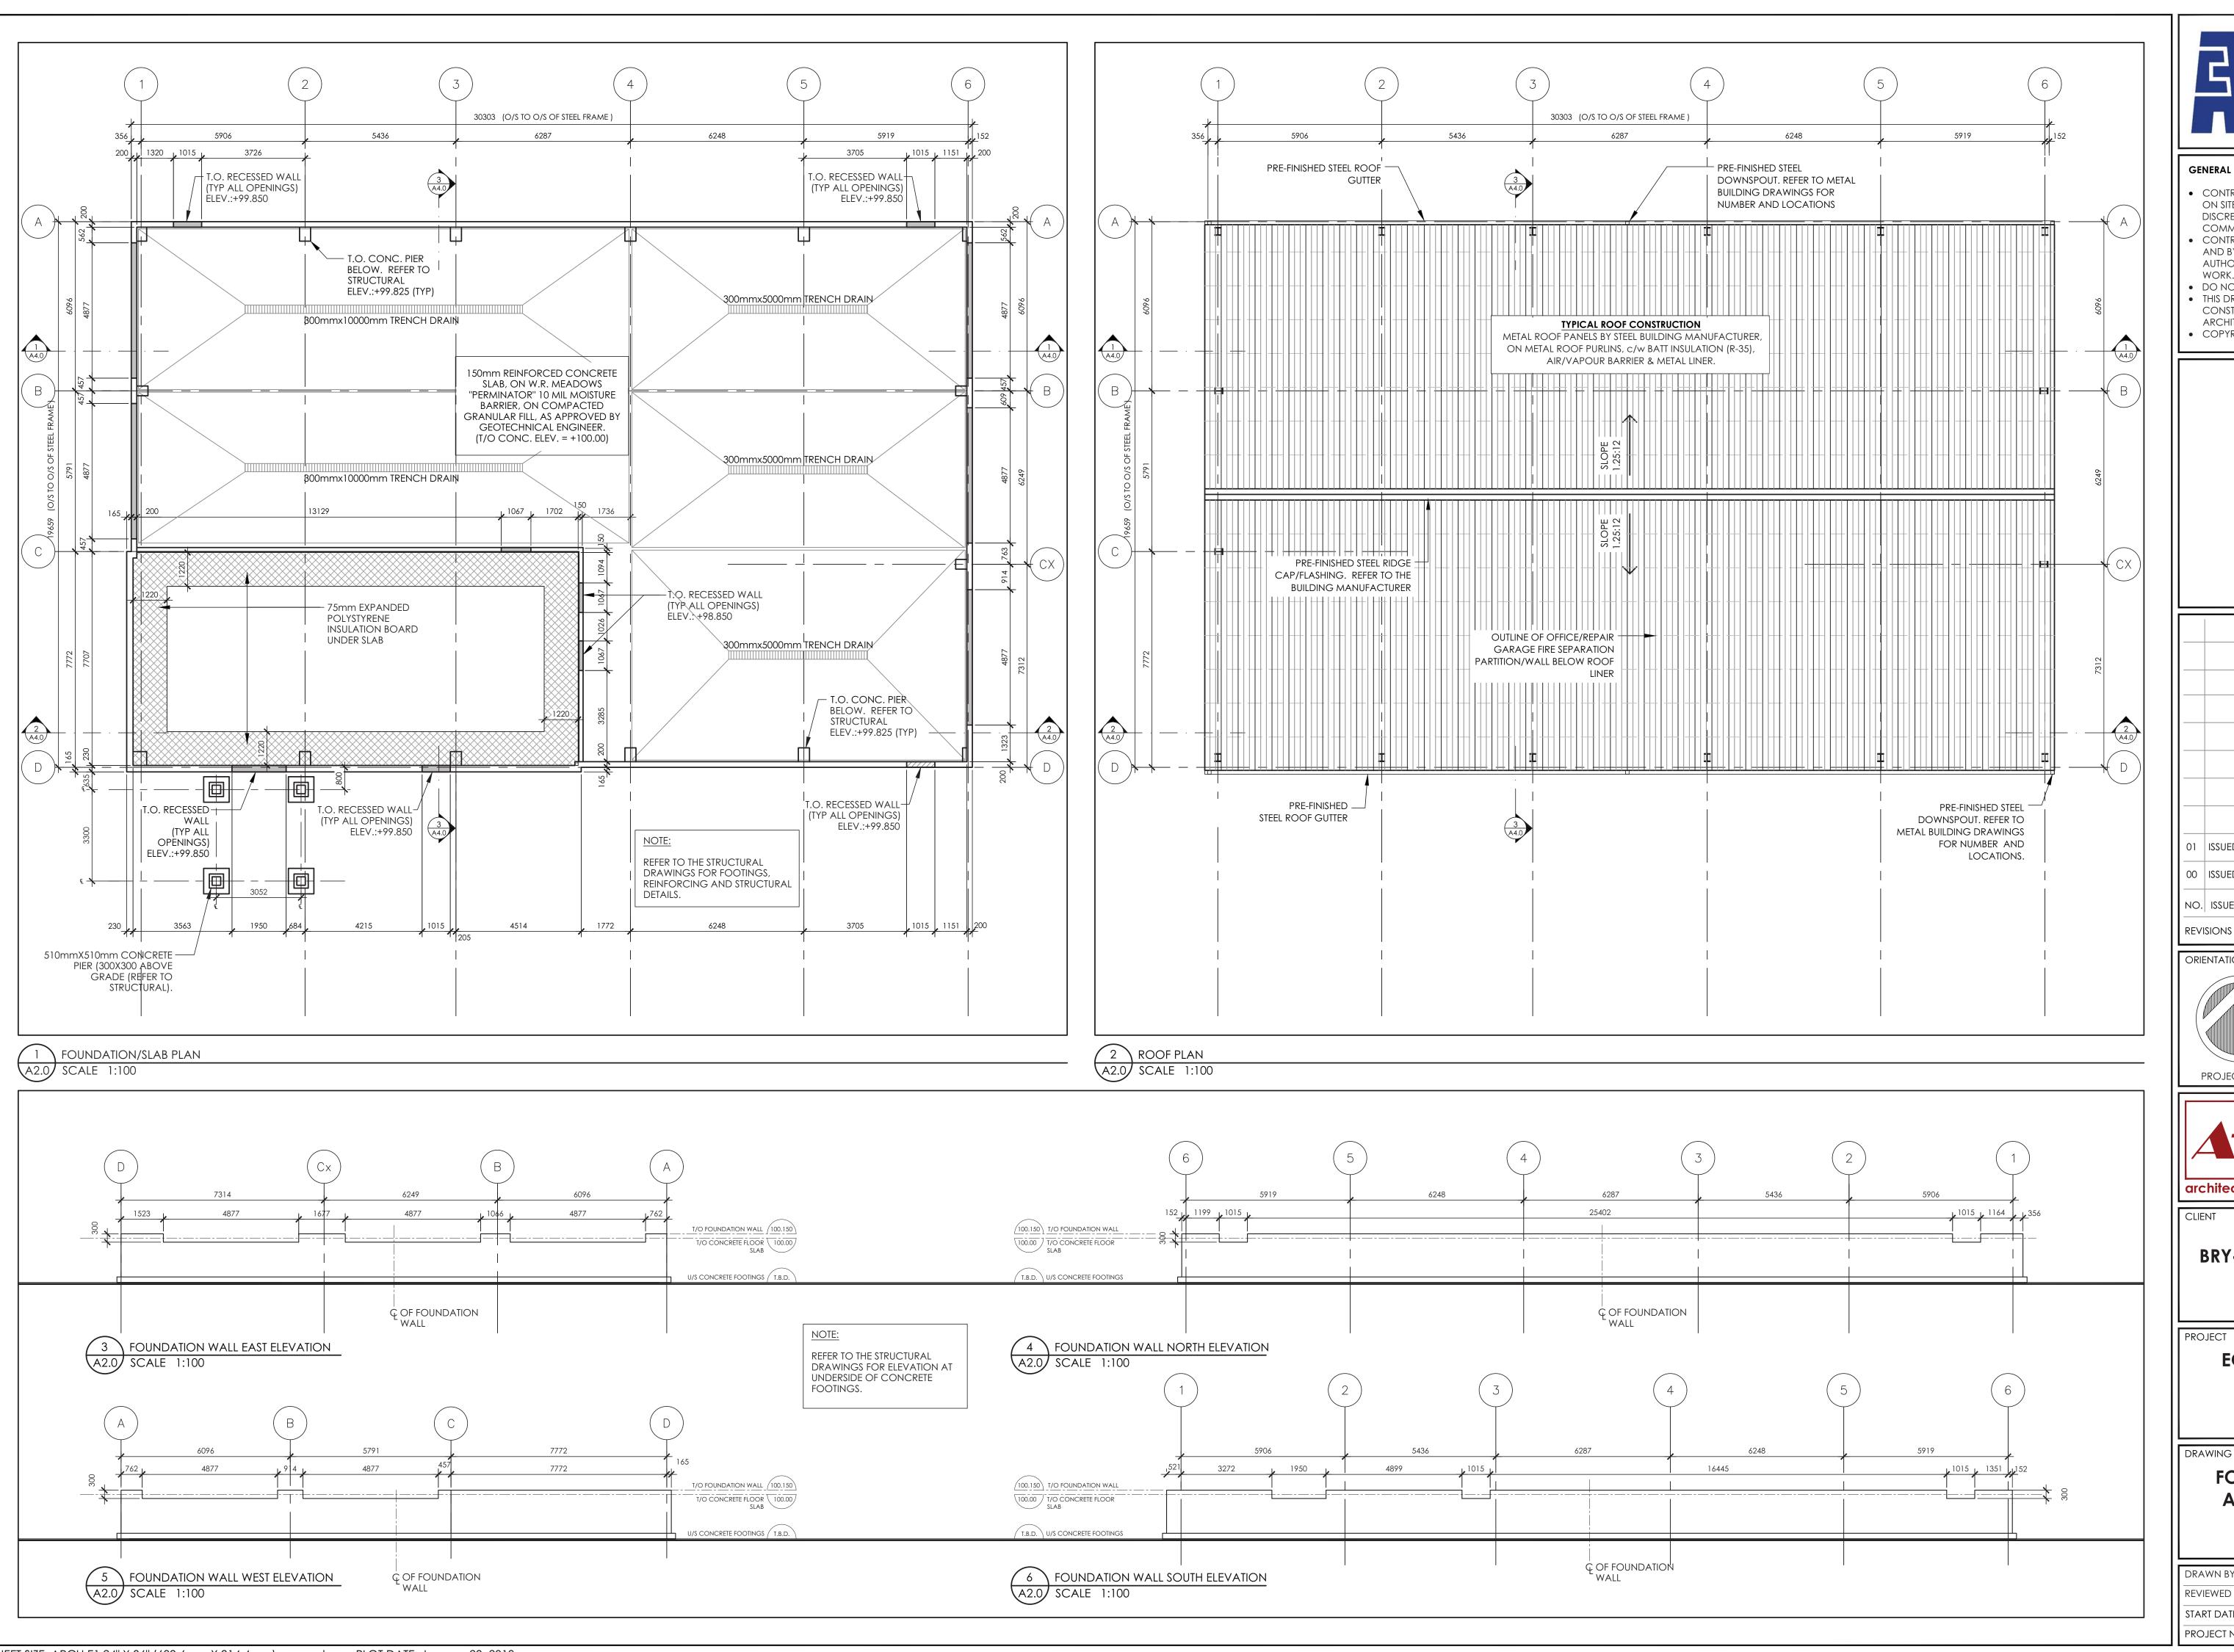




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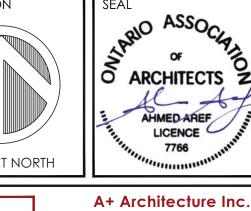
COMMENCEMENT OF WORK. CONTRACTOR MUST COMPLY WITH ALL CODES AND BYLAWS AND OTHER REGULATIONS BY AUTHORITIES HAVING JURISDICTION OVER THE

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01 ISSUED FOR BUILDING PERMIT 2018/01/29 00 ISSUED FOR COORDINATION 2018/01/08 NO. ISSUE DATE (YY/MM/DE



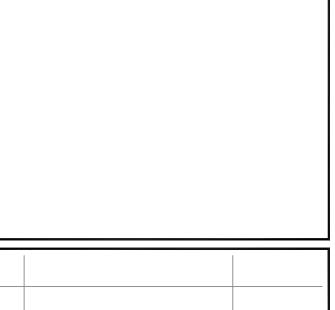



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PROJECT


EQUIPMENT REPAIR GARAGE

2688 CARP ROAD KANATA, ON KOA 1LO

DRAWING TITLE

FOUNDATION/SLAB AND ROOF PLANS

C.M. | DRAWING NO. DRAWN BY REVIEWED BY A2.0 START DATE 2017/06/05 PROJECT NO. 17004 REVISION NO.

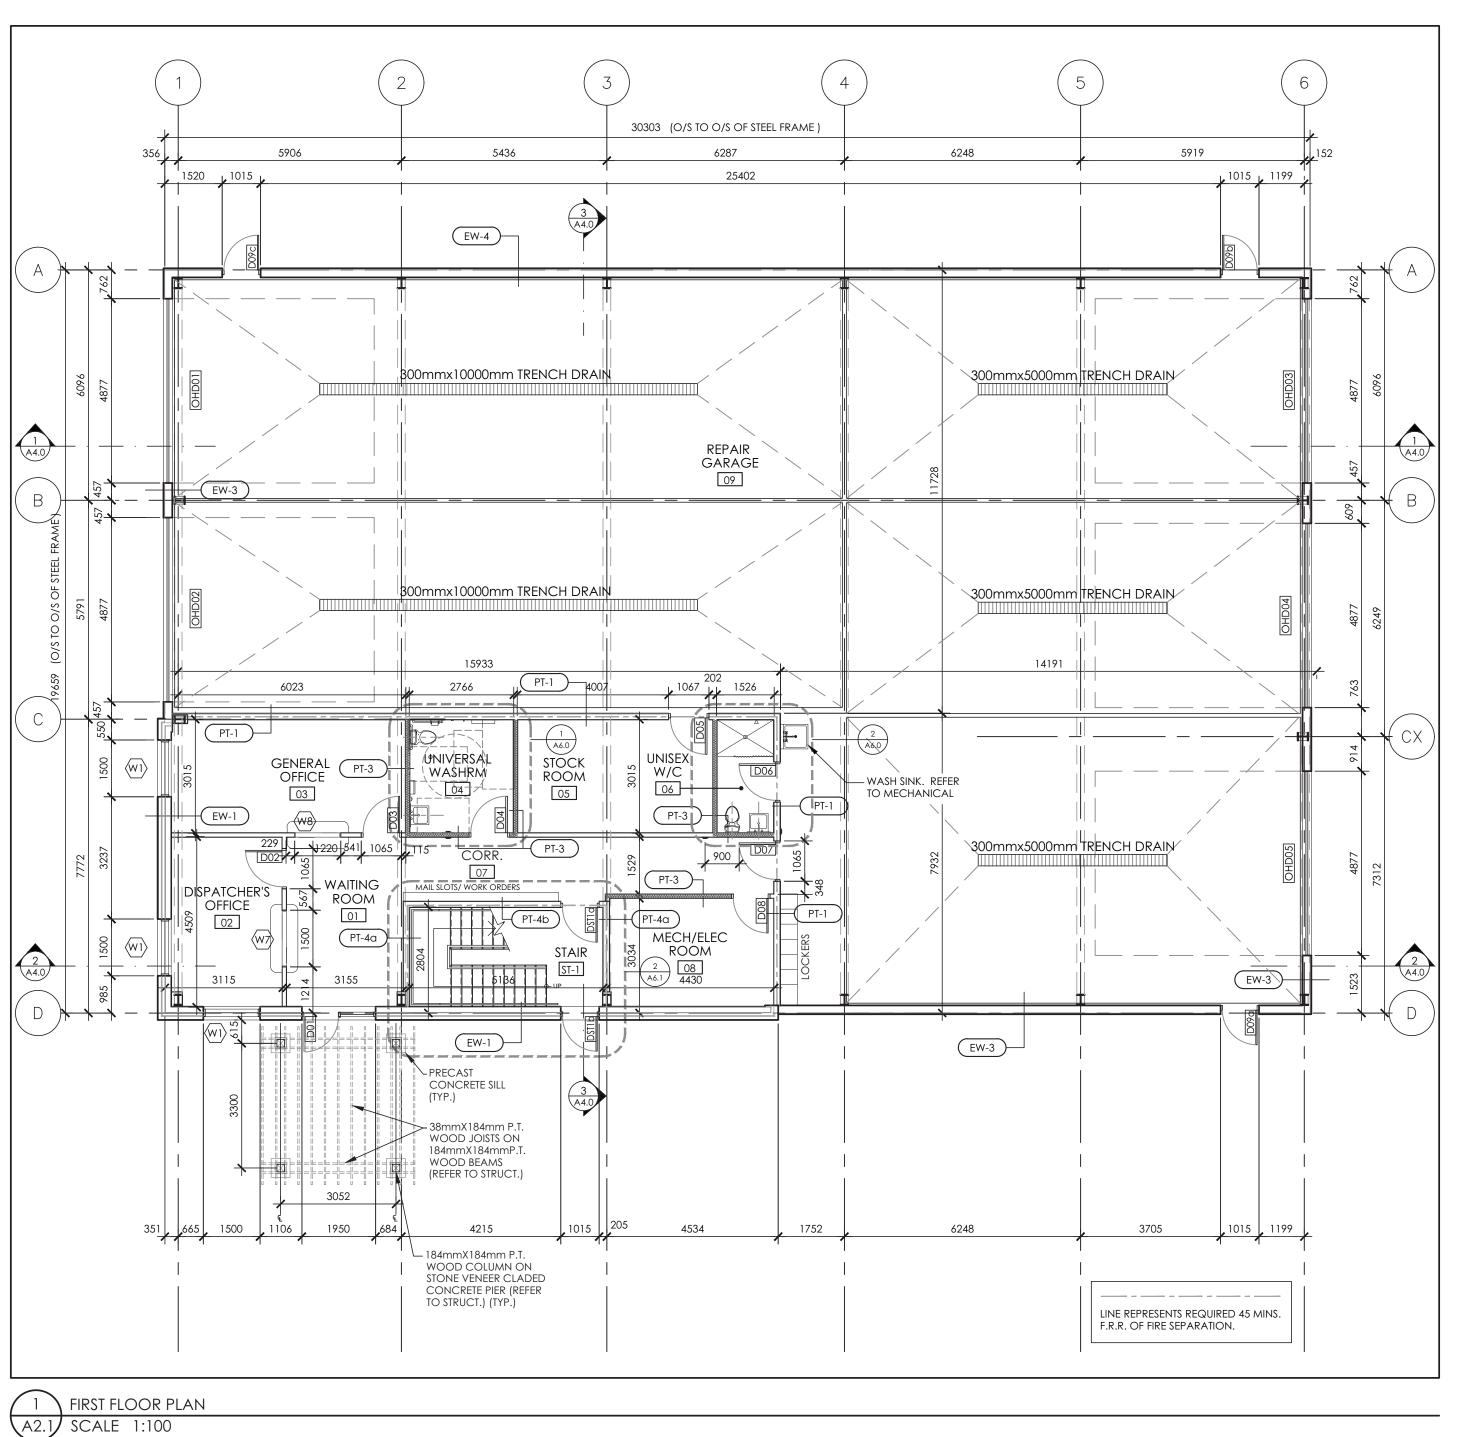


2 SECOND FLOOR PLAN A2.1 SCALE 1:100

(EW-2)

PRESIDENT

WALL TYPE SCHEDULE (ALL INTERIOR PARTITIONS SHALL BE OF (PT-2) ASSEMBLY TYPE, UNLESS OTHERWISE NOTED ON THE FLOOR PLANS)

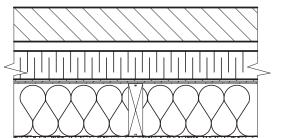

EXTERIOR WALLS @ OFFICE (TYP.) 25mm AIR SPACE, ON 75mm EPS INSULATION BOARD (R15), ON TYVEK AIR BARRIER, ON I 1mm EXTERIOR GRADE OSB SHEATHING, ON 38mm x140mm WOOD STUDS @ 400mm o.c., c/w 140mm ROXUL BATT INSULATION (R22), ON 6mil POLY VAPOR BARRIER, ON

EXTERIOR WALLS @ OFFICE (TYP.)
DUROCK PUCCS EIFS SYSTEM COMPRISING OF

STUCCO FINISH COAT, REINFORCING FIBREMESH

DEFINED DRAIN CAVITIES & POLAR BEAR MOISTURE

38mm x140mm WOOD STUDS @ 400mm O.C., c/w

INSULATION (R15) WITH 10mm GEOMETRICALLY

1 1mm EXTERIOR GRADE OSB SHEATHING, ON

140mm ROXUL BATT INSULATION (R22), ON

REPAIR GARAGE EXTERIOR WALL (TYP.)

VINYL-FACED BLANKET INSULATION, ON

WALL BY METAL BUILDING MANUFACTURER

GALVANIZED CORRUGATED STEEL PANEL, ON

OPTIONAL GALVANIZED STEEL INTERIOR LINER PANEL

BARRIER/AIR BARRIER, ON

6mil POLY VAPOR BARRIER, ON

13mm GYPSUM WALL BOARD

STRUCTURAL STEEL GIRTS, c/w


AIR/VAPOUR BARRIERS, ON


EW-4


EMBEDDED IN A BASE PRIMER/COAT, 102mm TYP 1 EPS

EW-1



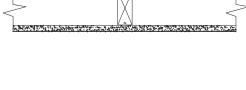

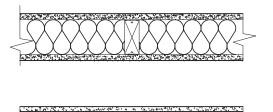

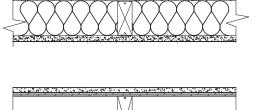





TYPICAL WASHROOM & M/E ROOM PARTITIONS

13mm GYPSUM WALL BOARD.

OFFICE/REPAIR GARAGE INTERIOR PARTITION

13mm GYPSUM WALL BOARD (TYPE X), ON

38mmX 140mm WOOD STUDS @ 400mm O.C.,

9.5mm OSB SHEATHING BOARD, ON

6mil POLY VAPOUR BARRIER, ON

C/W ROXUL BATT INSULATION (R22), ON

13mm GYPSUM WALL BOARD (TYPE X)

(1 HR F.R.R., FIRE SEPARATION SB-3 WALL NO. W1b

TYPICAL INTERIOR NON-LOAD BEARING PARTITION

38mmX89mm WOOS STUDS @ 400mm o.c, ON

38mm X89mm WOOD STUDS @ 400mm O.C., c/w 89mm SAFB BATT INSULATION IN BETWEEN STUDS TO FILL VOID ENTIRELY, ON 13mm GYPSUM WALL BOARD

EXIT STAIR WALL CONSTRUCTION 45min. FRR, FIRE SEPARATION, SB-3 WALL NO. W1e 13mm GYPSUM WALL BOARD (TYPE X), ON 38mm X140mm WOOD STUDS @ 400mm O.C., ON

13mm GYPSUM WALL BOARD (TYPE X)

13mm GYPSUM WALL BOARD (TYPE X)

13mm GYPSUM WALL BOARD (TYPE X)


EXIT STAIR WALL CONSTRUCTION 45min. FRR, FIRE SEPARATION, SB-3 WALL NO. W1e

38mm X140mm WOOD STUDS @ 400mm O.C., ON

9.5mm PLYWOOD SHEATHING (REFER TO STRUCTURAL), ON

STRUCTURAL FIREPROOFING DETAILS

3048

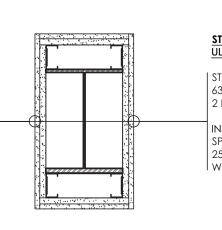

STEEL COLUMN/BEAM ENCLOSURE CONSTRUCTION (TYP.) ULC DESIGN NO. O501 & X528 | STRUCTURAL STEEL COLUMN/BEAM BY METAL BUILDING MANUFACTURER

15933

STORAGE

5428

STAIR PT-4a)

63mm STEEL METAL STUDS @ COLUMN/BEAM CORNERS 2 LAYERS OF 16mm GYPSUM WALL BOARD (TYPE X) INSTALL GYPSUM BOARD VERTICALLY WITH 25mm (1") SCREWS SPACED 300mm(12") O.C. APPLY CORNER BEAD WITH 25mm (1") SCREWS SPACED 300mm(12") O.C. TAPE AND FINISH JOINTS WITH ULC-APPROVED PRODUCTS.

GENERAL NOTES

30303 (O/S TO O/S OF STEEL FRAME)

— REPAIR GARAGE — BELOW

M/W M/W

LUNCH ROOM

1. ALL DESIGN AND CONSTRUCTION IS TO MEET THE REQUIREMENTS OF THE CURRENT UPDATE OF THE 2012 EDITION OF THE ONTARIO BUILDING CODE.

LINE REPRESENTS REQUIRED 45 MINS.

F.R.R. OF FIRE SEPARATION.

EW-3

- 2. VERIFY ALL DIMENSIONS ON SITE AND OBTAIN ARCHITECT'S PERMISSION TO MODIFY BEFORE PROCEEDING.
- 3. PROTECT ALL EXISTING UTILITIES. CONTACT ALL REQUISITE MUNICIPAL AND UTILITY AUTHORITIES FOR LOCATES AND CARRY OUT WORK TO THEIR APPROVAL.
- 4. PRE-ENGINEERED THERMAL INSULATION AND AIR/VAPOUR BARRIER WITHIN THE REPAIR GARAGE EXTERIOR WALLS AND ROOF BY METAL BUILDING MANUFACTURER. OFFICE EXTERIOR WALLS AND ROOF CONSTRUCTION TO MEET THE REQUIREMENTS OF PART 12 OF THE ONTARIO BUILDING CODE.
- AND WINDOW FRAMES, LOUVERS, VENTS, THRESHOLD. ETC., AND BETWEEN DIFFERENT EXTERIOR MATERIALS. PACK SPACES DEEPER THAN 13mm (1/2") AND WIDER THAN 6mm (1/4") WITH CLOSED-CELL POLY BACKER ROPE. MATERIALS: 'DYMERIC' BT TREMCO CANADA LTD. OR DOWN CORNING 790 SILICONE BUILDING SEALANT. WASHROOM SEALANT - FUNGUS AND MILDEW RESISTANT SILICONE. SHOWER CAULK - 'TREMSIL 600' BY TREMCO OR DOW CORNING 786. 6. FIRESTOP ALL FLOORS/WALLS/CEILING PARTITION FIRE SEPARATIONS AT ALL ROOF DECKS, BEAMS, COLUMNS, PENETRATIONS

5. CAULK AND SEAL TO ENSURE A COMPLETE WEATHER AND WATERTIGHT ASSEMBLIES INCLUDING AROUND ALL EXTERIOR DOOR

THAN 16mm (5/8") TO BE CAULKED. ALL GAPS GREATER THAN 16mm (5/8") - USE COMPRESSED MINERAL WOOL FILL AND APPROVED SEALANT: CP6015, CP606, FS-ONE BY HILTI CONSTRUCTION CHEMICALS, DIVISION OF HILTI INC. OR EQUAL. . Pressed Steel frames for doors and windows to be 16 gauge, satin coated galvanized steel A25, ready for PAINT. HOLLOW METAL DOORS TO BE 18 GAUGE SATIN COATED GALVANIZED STEEL A25, READY FOR PAINT. SOLID CORE


ETC. WITH ULC APPROVED AND LISTED MATERIALS & SYSTEMS. NO GAPS TO BE GREATER THAN 50mm (2"). ALL GAPS LESS


- WOOD DOORS TO BE 5-PLY, SOUND GRADE BIRCH FACE PANELS READY FOR PAINT. ALUMINUM WINDOWS, DOORS, FRAMES, GLASS, HARDWARE, COLUMN CLADDING AND TRIM TO BE INSTALLED IN A NEAT, WORKMAN LIKE MANNER. ACCURATELY CUT AND FIT TO TIGHTLY CLOSE FLUSH JOINTS. USE CONCEALED, NON-CORROSIVE FASTENINGS, BRACES ETC. LINE UP JOINTS WITH MULLIONS OR SIMILAR ARCHITECTURAL FEATURES. CAULK JOINTS TO MATCH FRAME COLOUR. APPLY CAULKING EVENLY AND
- 8. ACCESSIBILITY SIGNS ARE TO BE PROVIDED TO MEET THE REQUIREMENTS OF SECTION 3.8. OF THE O.B.C.
- 9. GYPSUM BOARD IN WASHROOMS SHALL BE MOISTURE-RESISTANT GYPSUM BOARD OR FIBRE GLASS GYPSUM PANELS.
- 10. AUTOMATIC DOOR OPENER (POWER OPERATORS) SHALL BE INSTALLED ON THE LATCH SIDE OF DOORS, AS LISTED ON THE DOOR HARDWARE SCHEDULE. INSTALL AUTOMATIC DOOR OPENERS 900mm - 1100mm FROM THE FINISHED FLOOR LEVEL, AND 600mm (MIN.) - 1500mm (MAX.) BEYOND THE DOOR SWING WHERE THE DOOR OPENS TOWARDS THE AUTOMATIC



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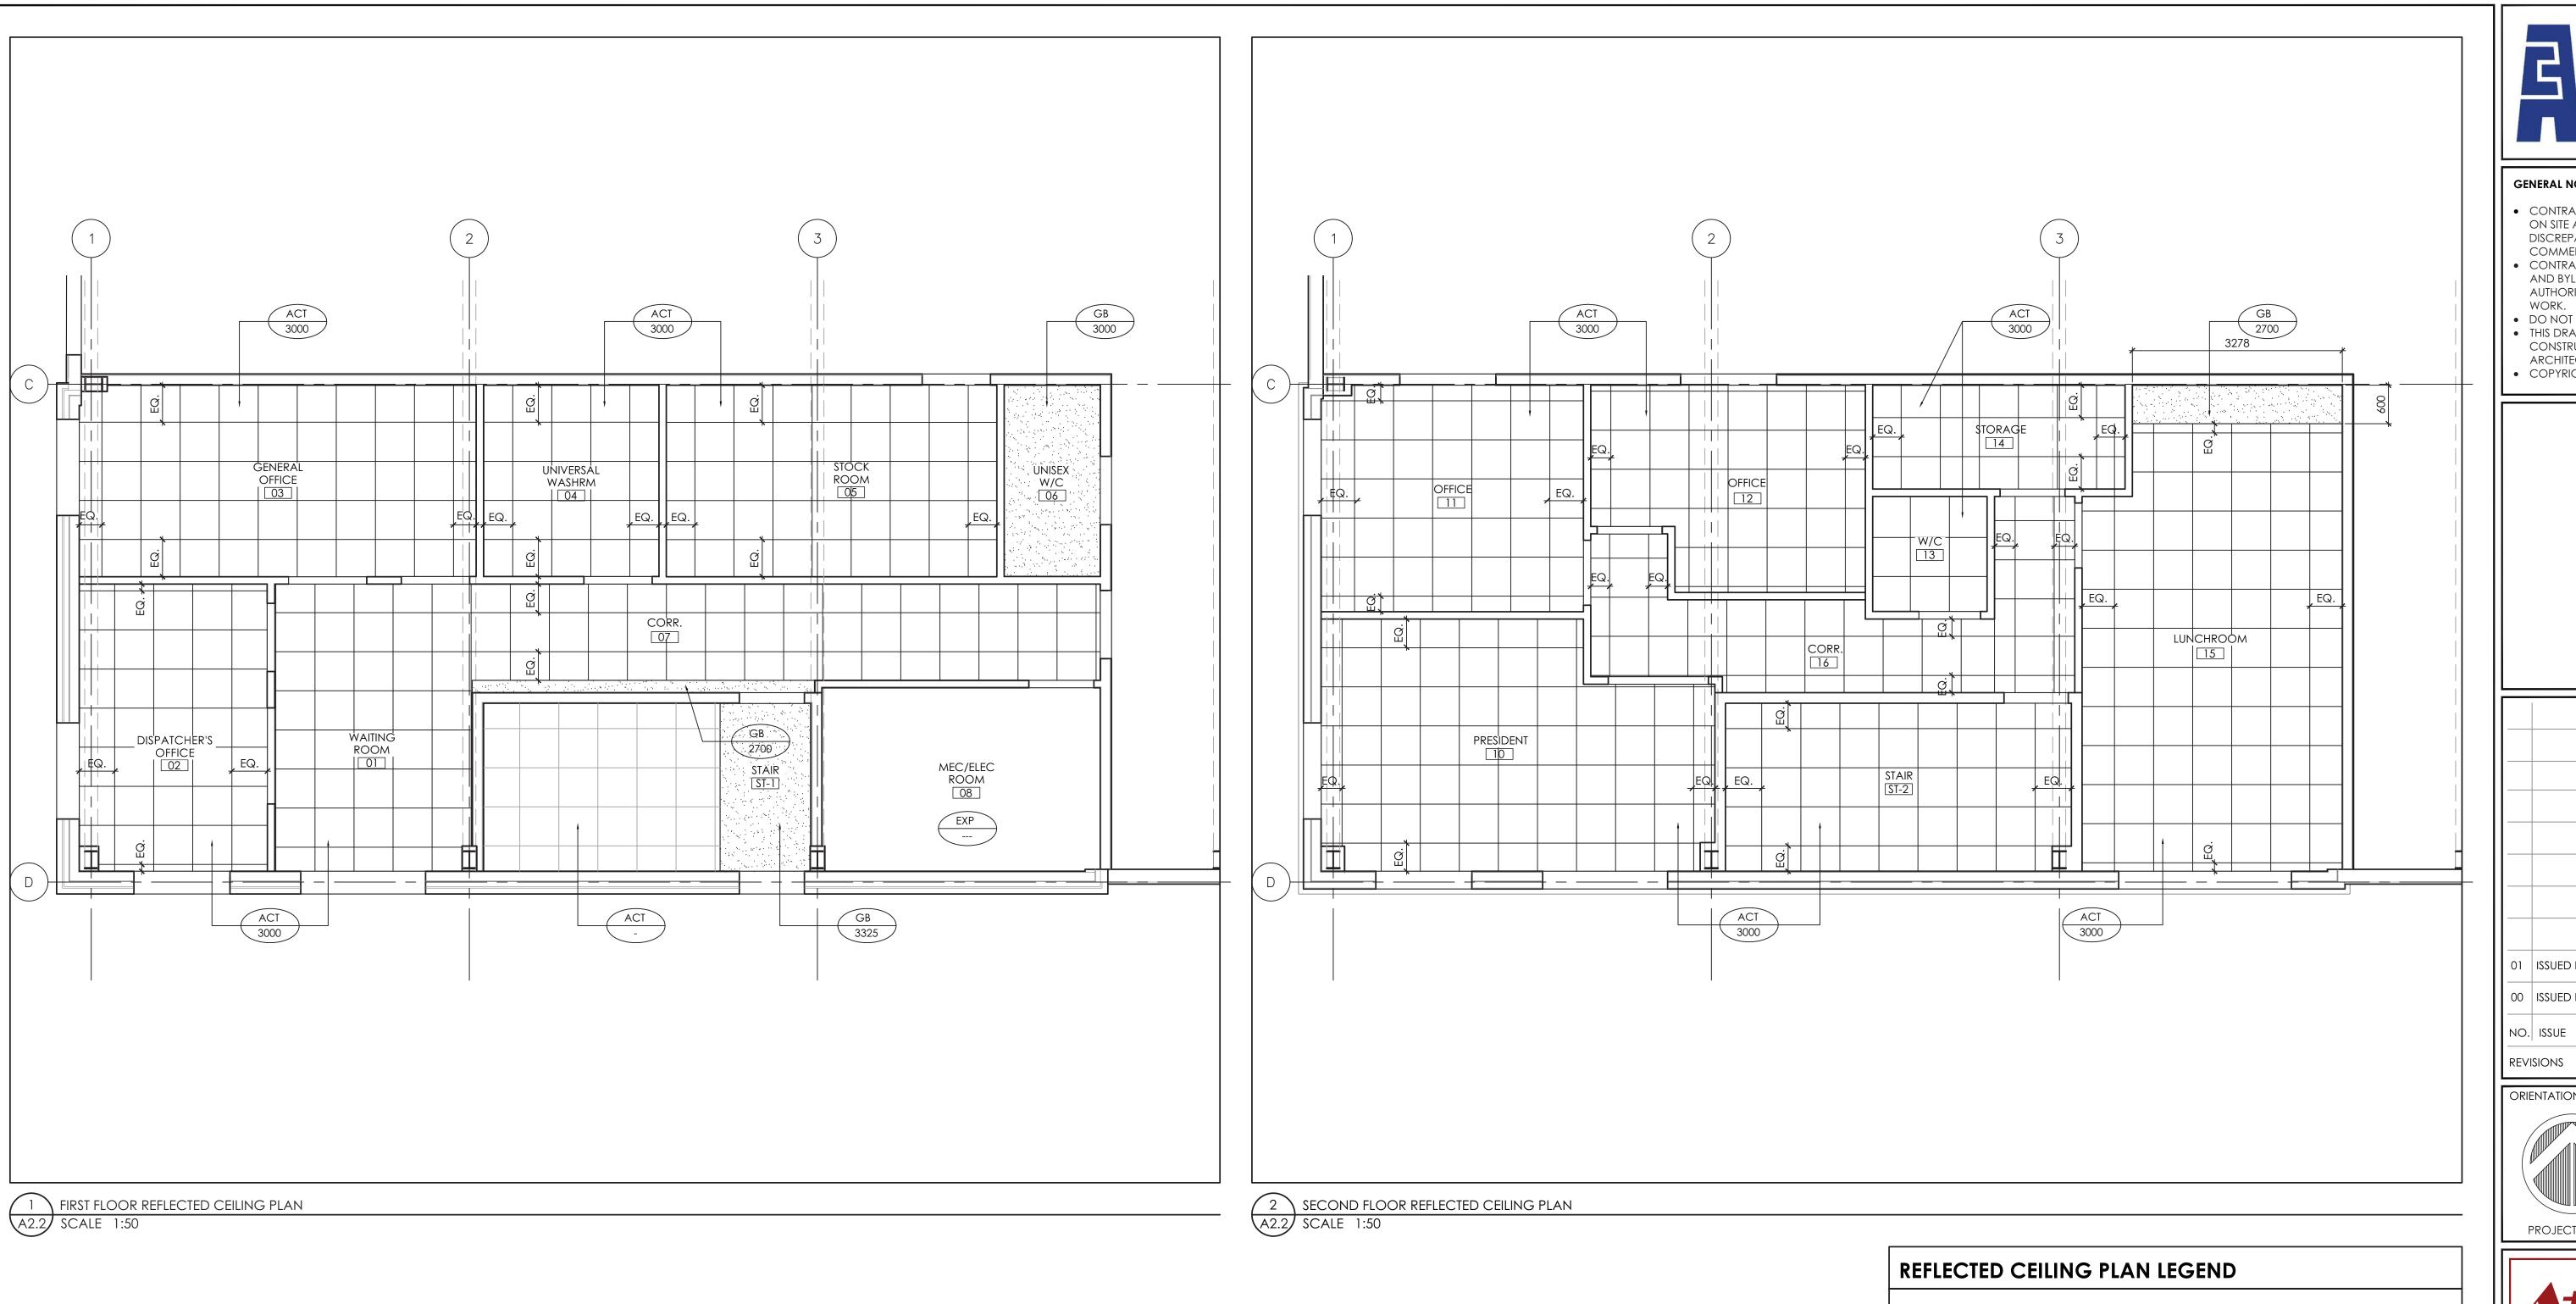
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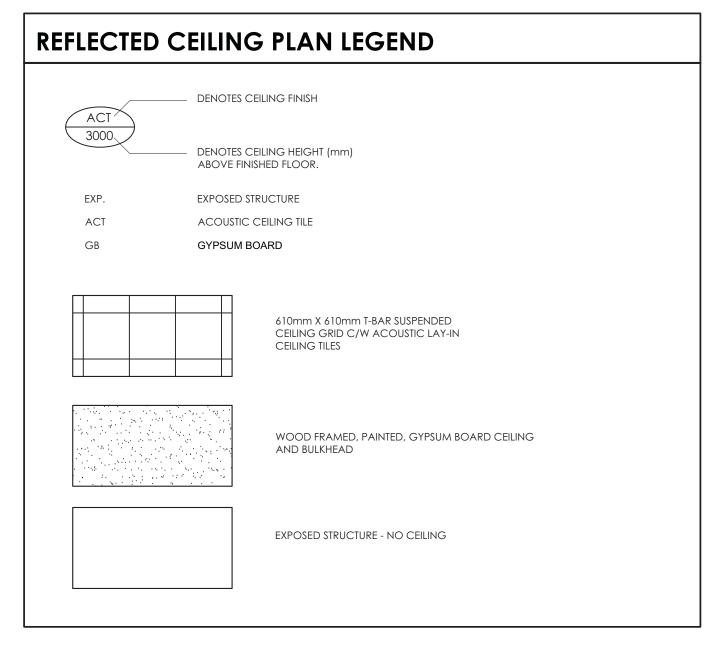
2688 CARP ROAD KANATA, ON KOA 1LO

DRAWING TITLE

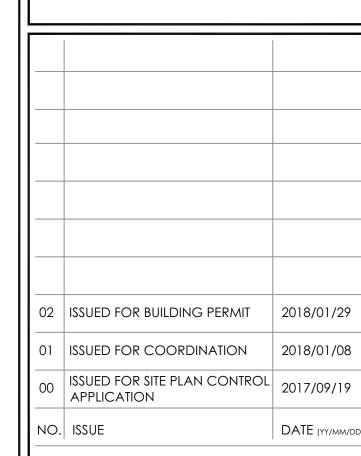FIRST AND SECOND FLOOR PLANS, **ASSEMBLIES**

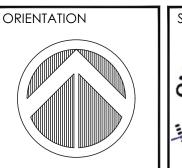
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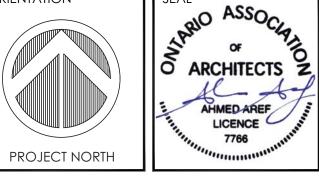




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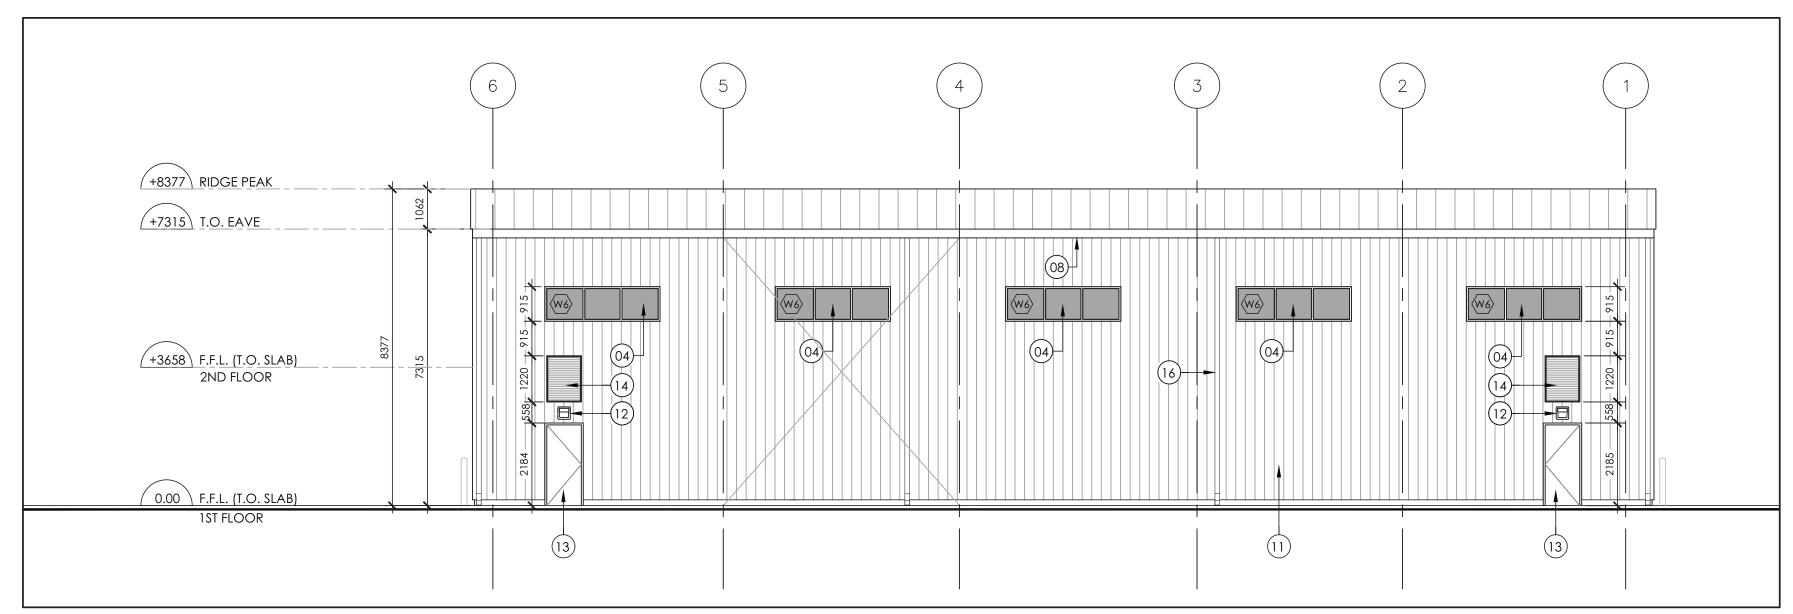
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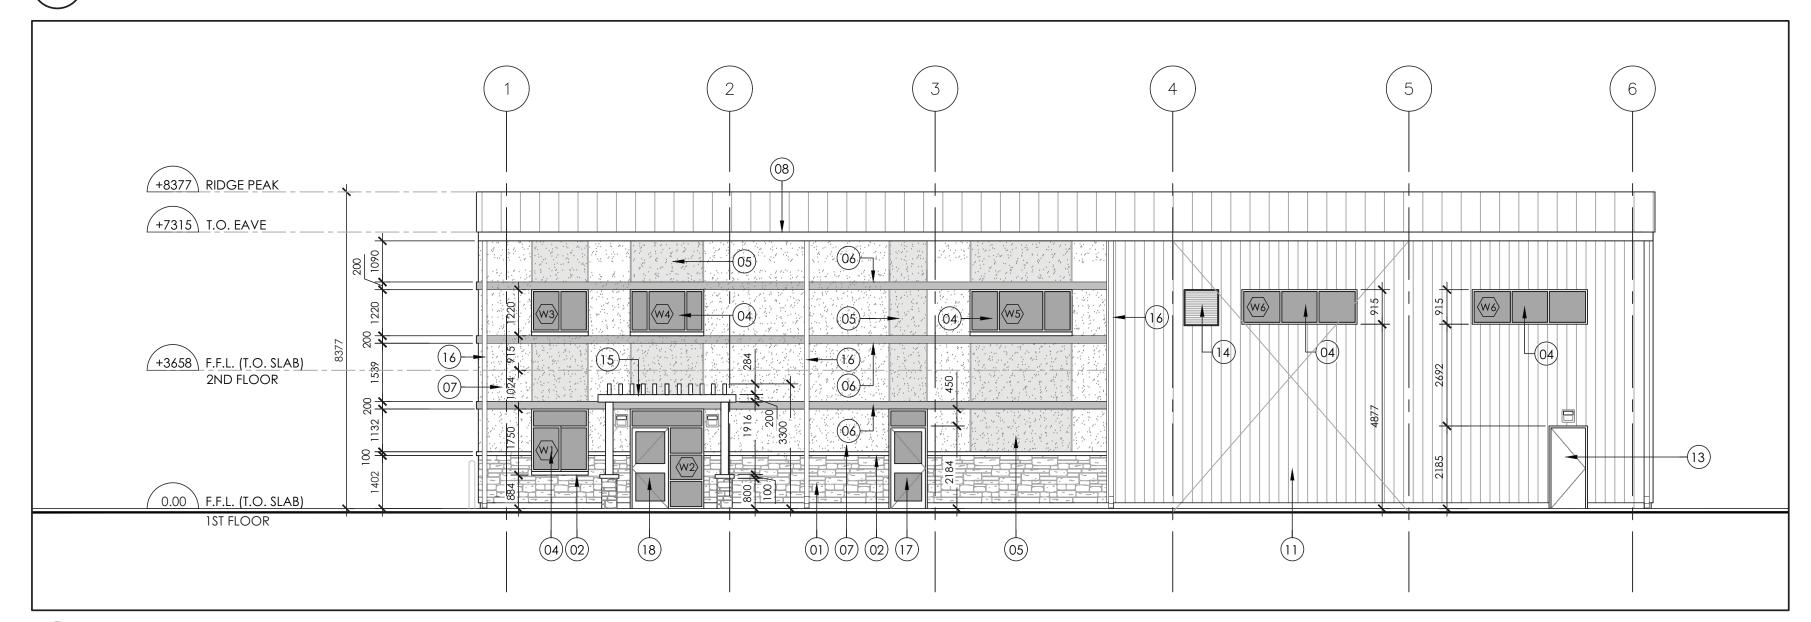
DRAWING TITLE

FIRST AND SECOND FLOOR REFLECTED CEILING **PLANS**

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1 EXTERIOR NORTH ELEVATION A3.0 SCALE 1:100

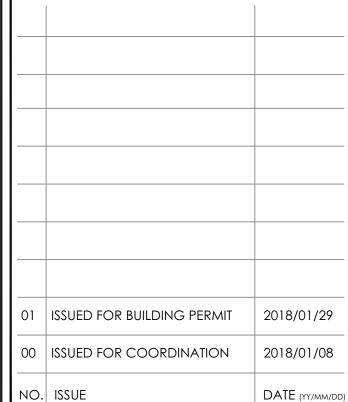


EXTERIOR ELEVATIONS NOTES


- 01) EXTERIOR ARCHITECTURAL STONE VENEER PRODUCT STYLE, FINISH AND COLOUR TO BE DETERMINED.
- 02) ARCHITECTURAL PRECAST CONCRETE SILL/CAP -PERMACON, BUFFED, COLOUR TO BE DETERMINED.
- (03) RESERVED.
- (04) DARK TINTED GLASS IN BLACK ANODIZED ALUMINUM
- 05 E.I.F.S. (ACCENT COLOUR) DRYVIT, SAND PEPPLE, COLOUR: TO BE DETERMINED.
- (06) E.I.F.S (TRIM/BAND) DRYVIT, SAND PEPPLE, COLOUR: TO BE DETERMINED.
- 07 E.I.F.S. (GENERAL COLOUR) DRYVIT, SAND PEPPLE, COLOUR: TO BE DETERMINED.
- (08) PRE-FINISHED METAL ROOF GUTTER/EAVESTROUGH.
- 09 4875 (W) X 4875 (H) INSULATED SECTIONAL STEEL OVERHEAD DOOR.
- 10) 150 Ø CONCRETE FILLED STEEL BOLLARD (TYP.). PAINT
- FINISH COLOUR: TO BE DETERMINED. 32mm GALVANIZED CORRUGATED STEEL PANEL. PBR PANEL FROM ROBERTSON BUILDING SYSTEMS.
- 12) EXTERIOR WALL MOUNTED LIGHT FIXTURE (TYP.).

COLOUR: TO BE DETERMINED.

- 3) EXTERIOR INSULATED STEEL DOOR AND FRAME. PAINT COLOUR: CHARCOAL.
- (14) MECHANICAL HVAC/FAN LOUVER C/W PRE-FINISHED EXTERIOR METAL TRIM.
- MAPLE FINISHED WOOD TRELLIS/ENTRANCE CANOPY
 ON (4) WOOD POSTS AND CONCRETE PIER
- 6 PRE-FINISHED STEEL DOWNSPOUT. COLOUR TO MATCH BUILDING CORRUGATED STEEL PANEL.
- EXTERIOR INSULATED ALUMINUM DOOR AND FRAME WITH DARK TINTED GLASS.
- (18) EXTERIOR INSULATED ALUMINUM STOREFRONT DOOR AND SIDELIGHT ASSEMBLY WITH DARK TINTED GLASS.

2 EXTERIOR SOUTH ELEVATION A3.0 SCALE 1:100

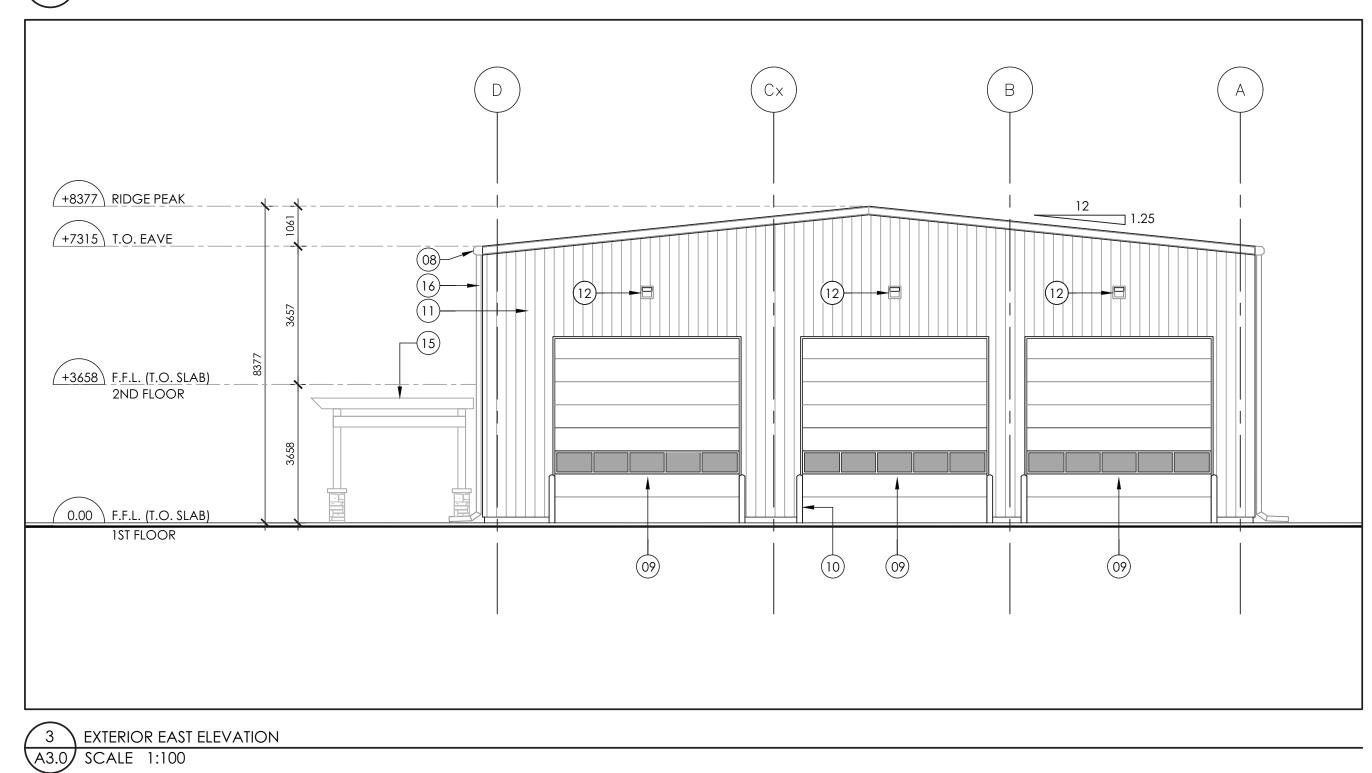


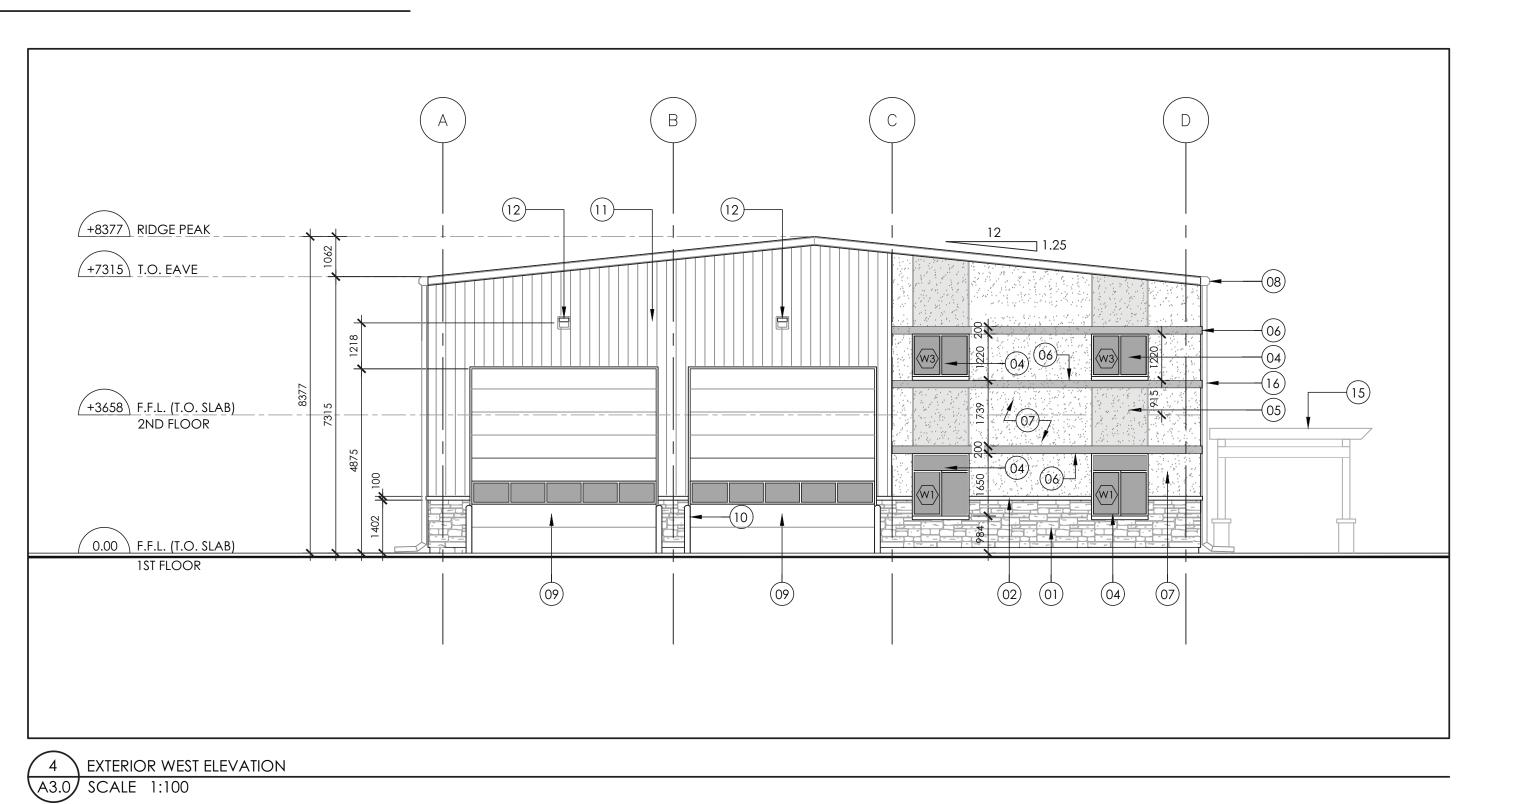





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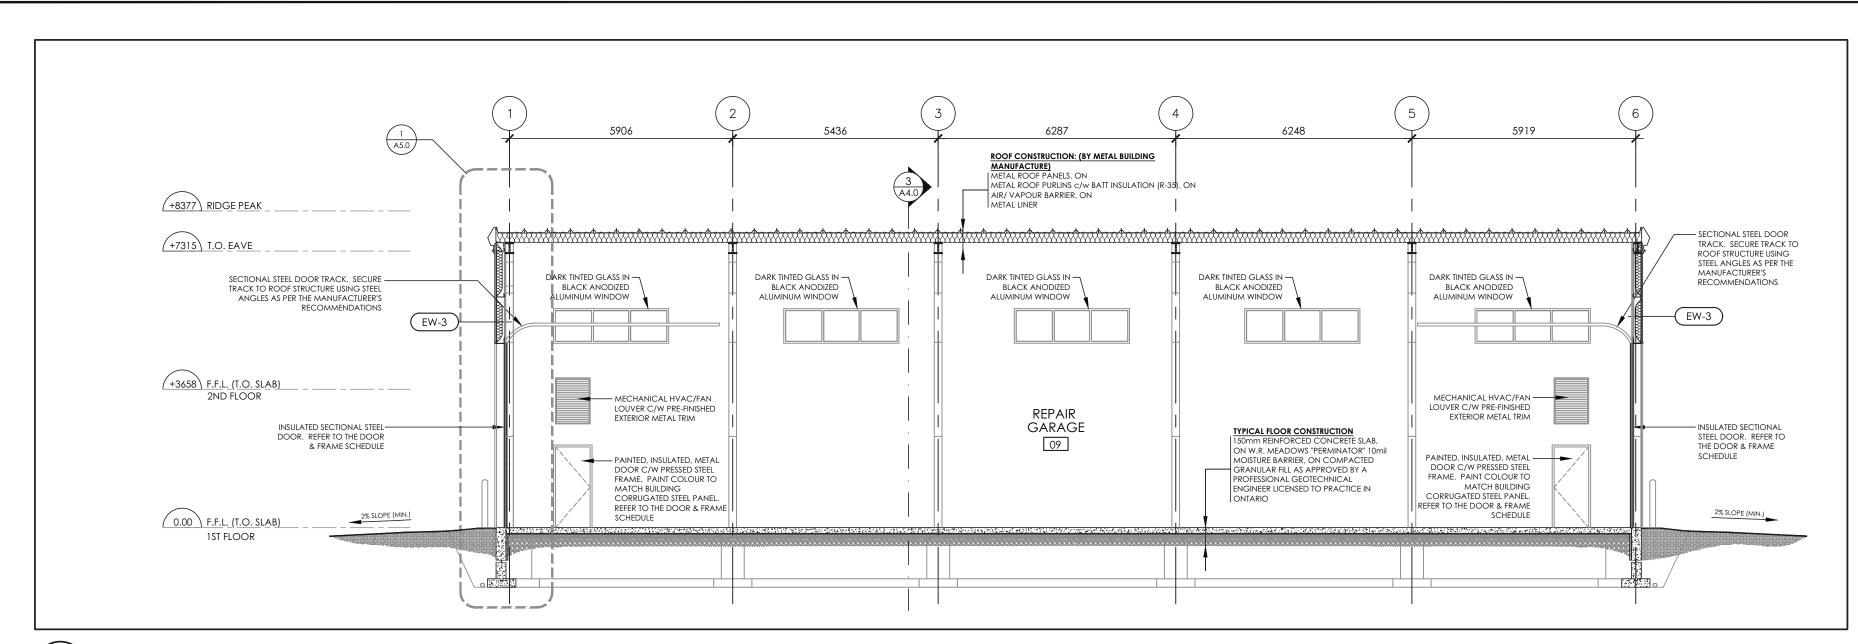
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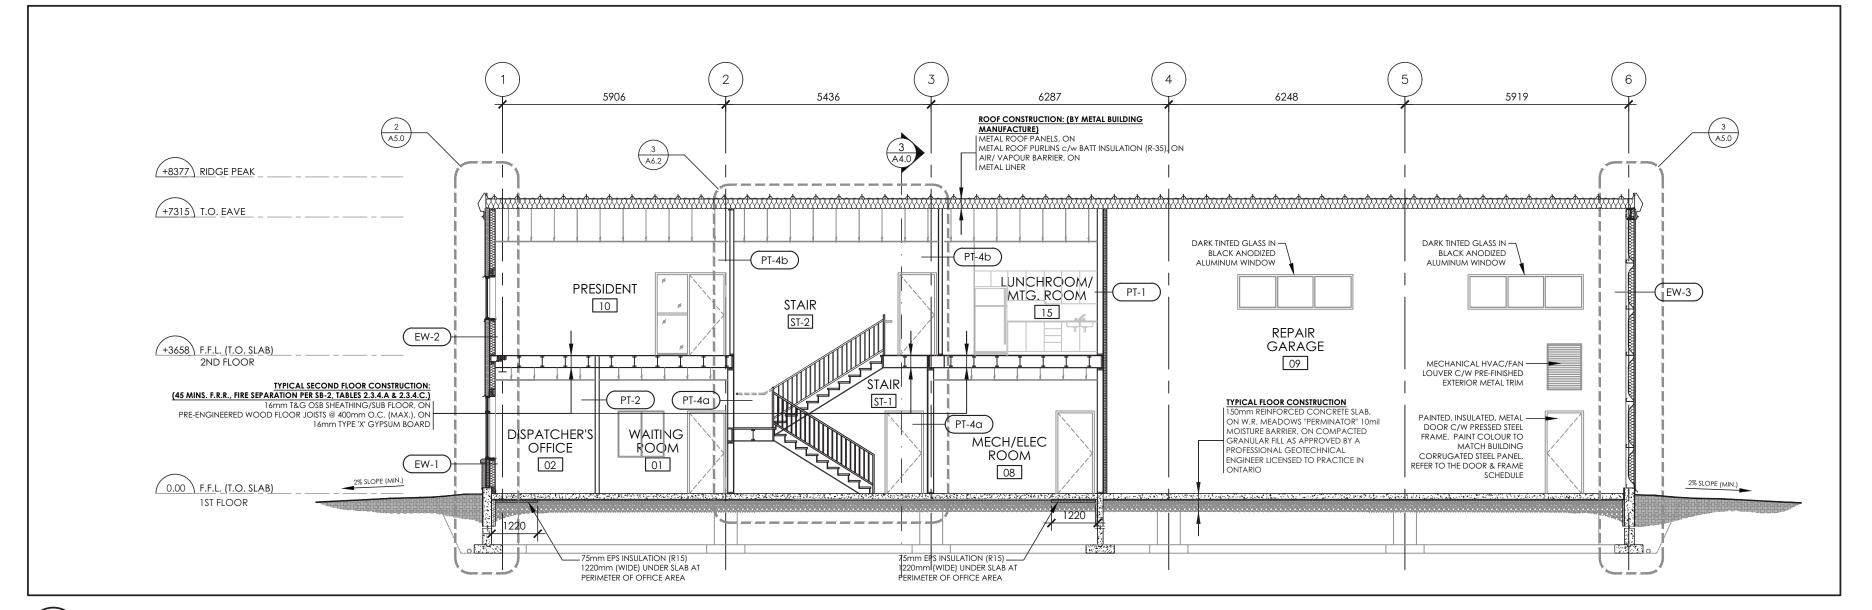
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EXTERIOR ELEVATIONS


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REVIEWED BY	A.A.	٨2
START DATE 201	7/06/05	A3.
PROJECT NO.	17004	REVISION NO.

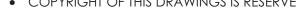

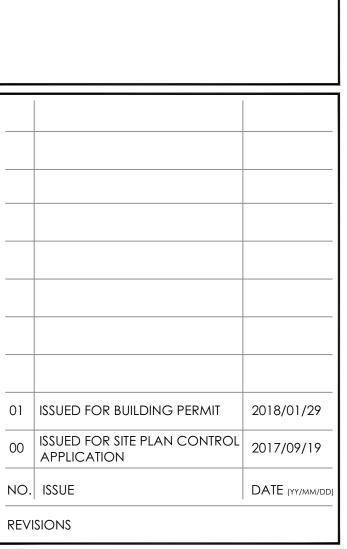BUILDING SECTION A4.0 SCALE 1:100

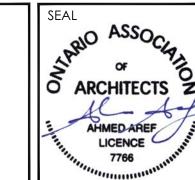

BUILDING SECTION A4.0 SCALE 1:100

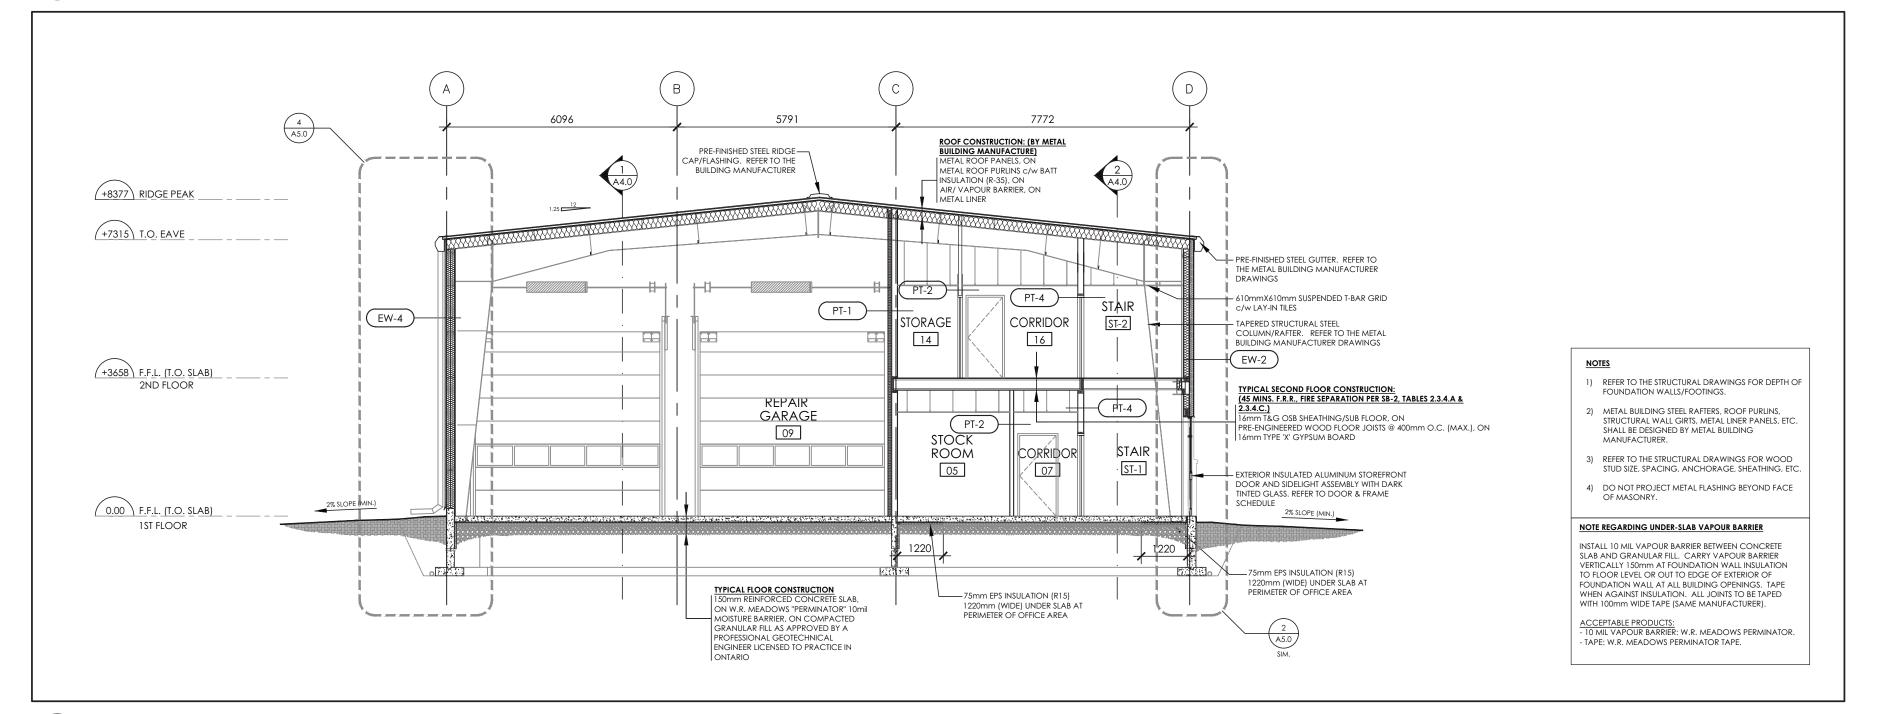


3 BUILDING SECTION
A4.0 SCALE 1:100




GENERAL NOTES


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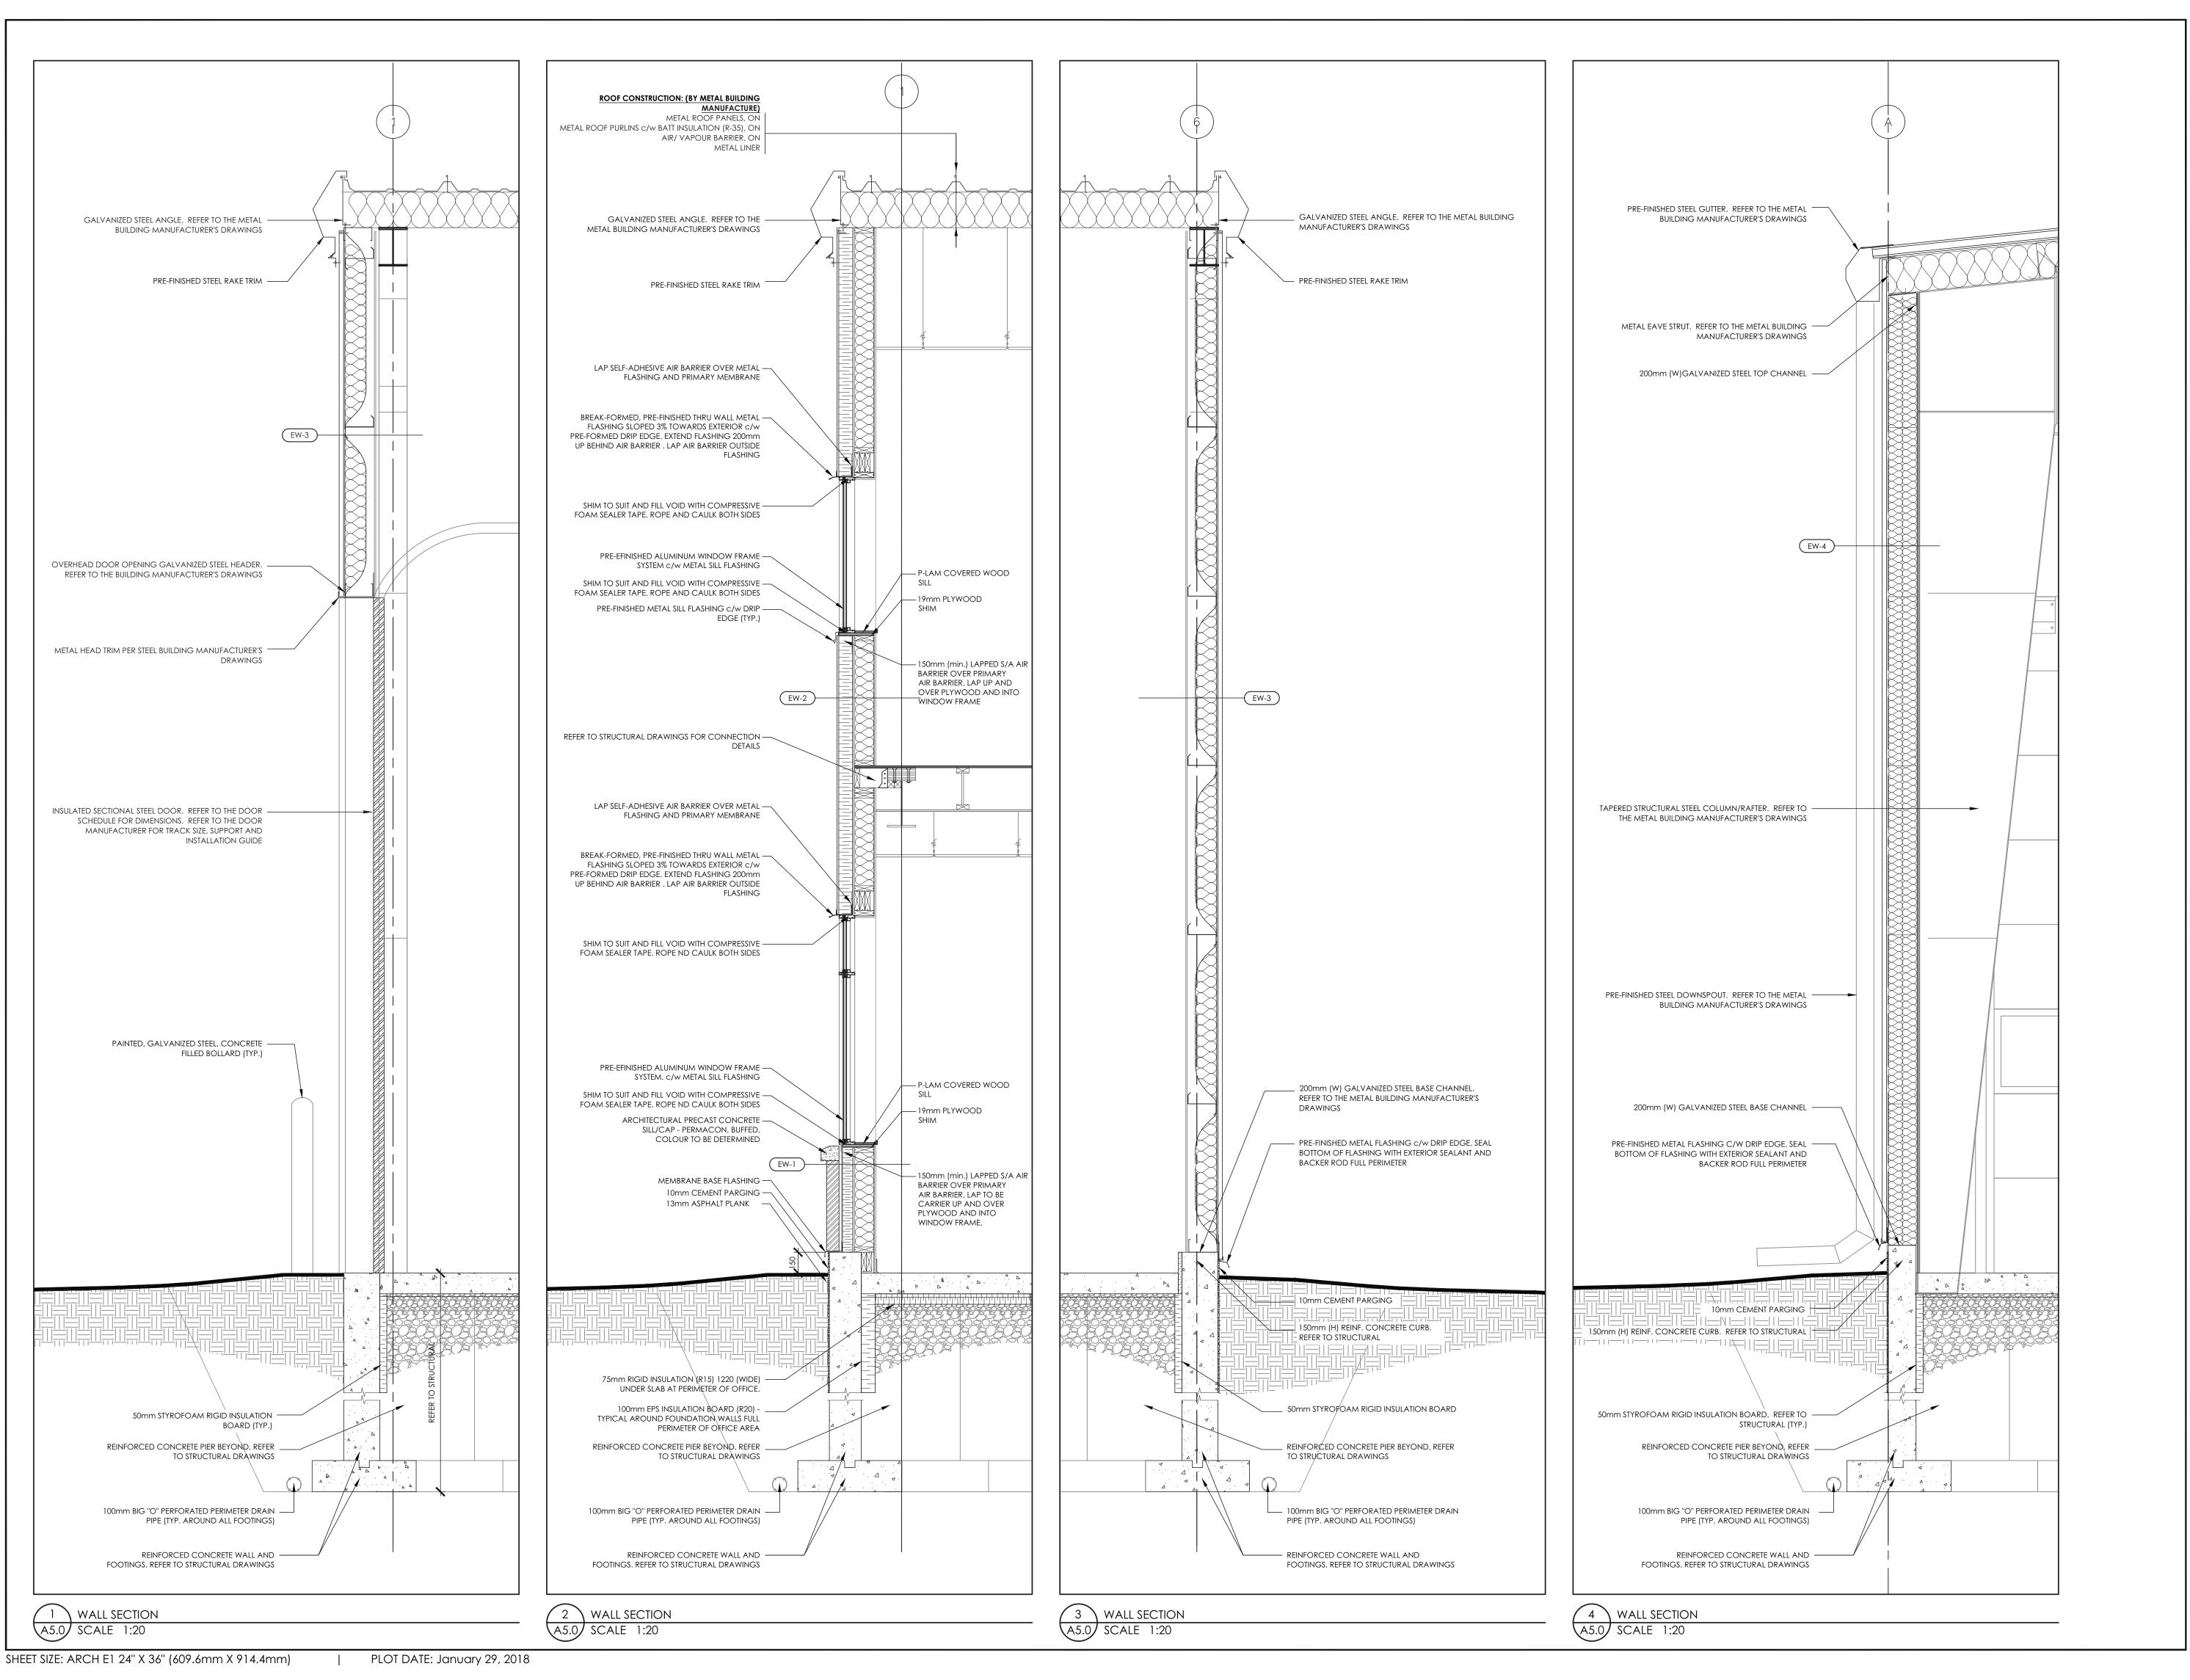
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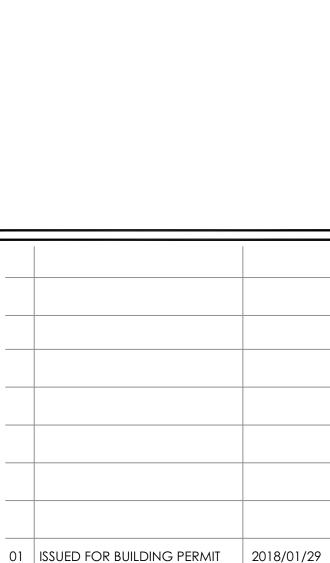
BUILDING SECTIONS

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ı	PROJECT NO.	17004	REVISION NO.	0

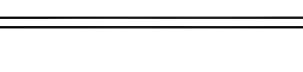

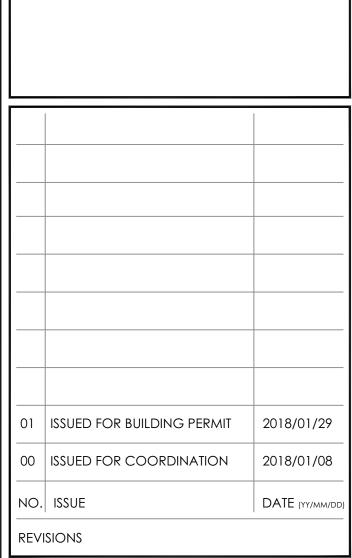

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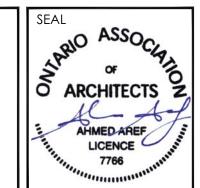

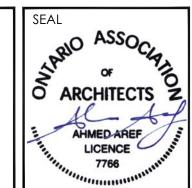
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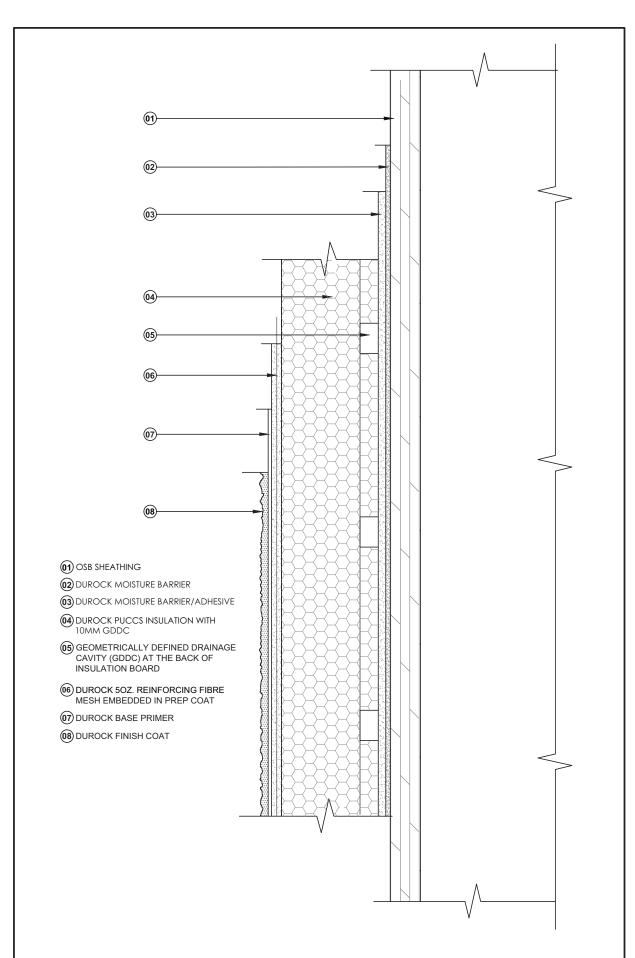
WALL SECTIONS

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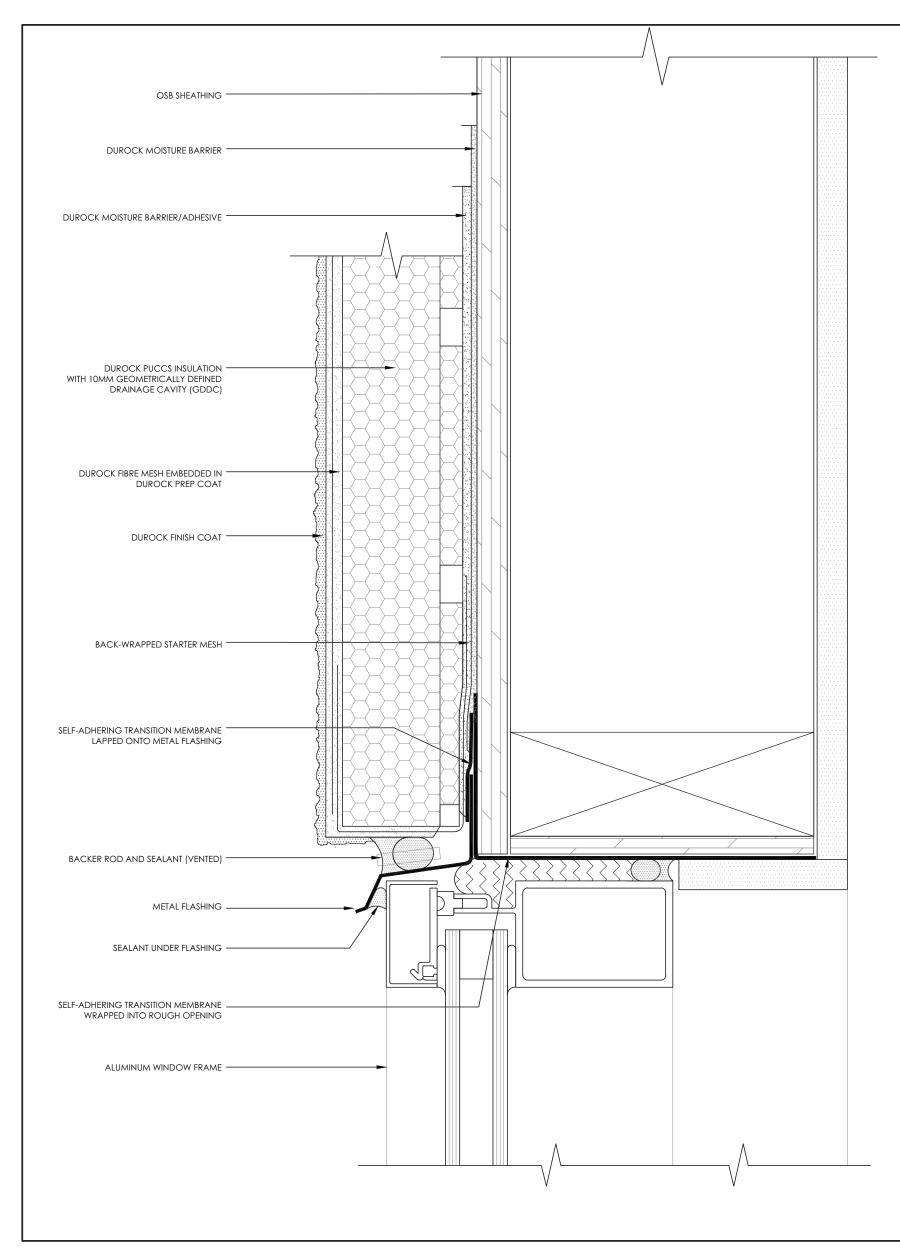
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START DATE 2017/06/05


PROJECT NO. 17004 | REVISION NO.



1 EIFS STANDARD CONSTRUCTION DETAIL (TYP.)



2 EIFS @ ALUMINUM WINDOW HEAD DETAIL (TYP.)
A5.1 SCALE 1:2

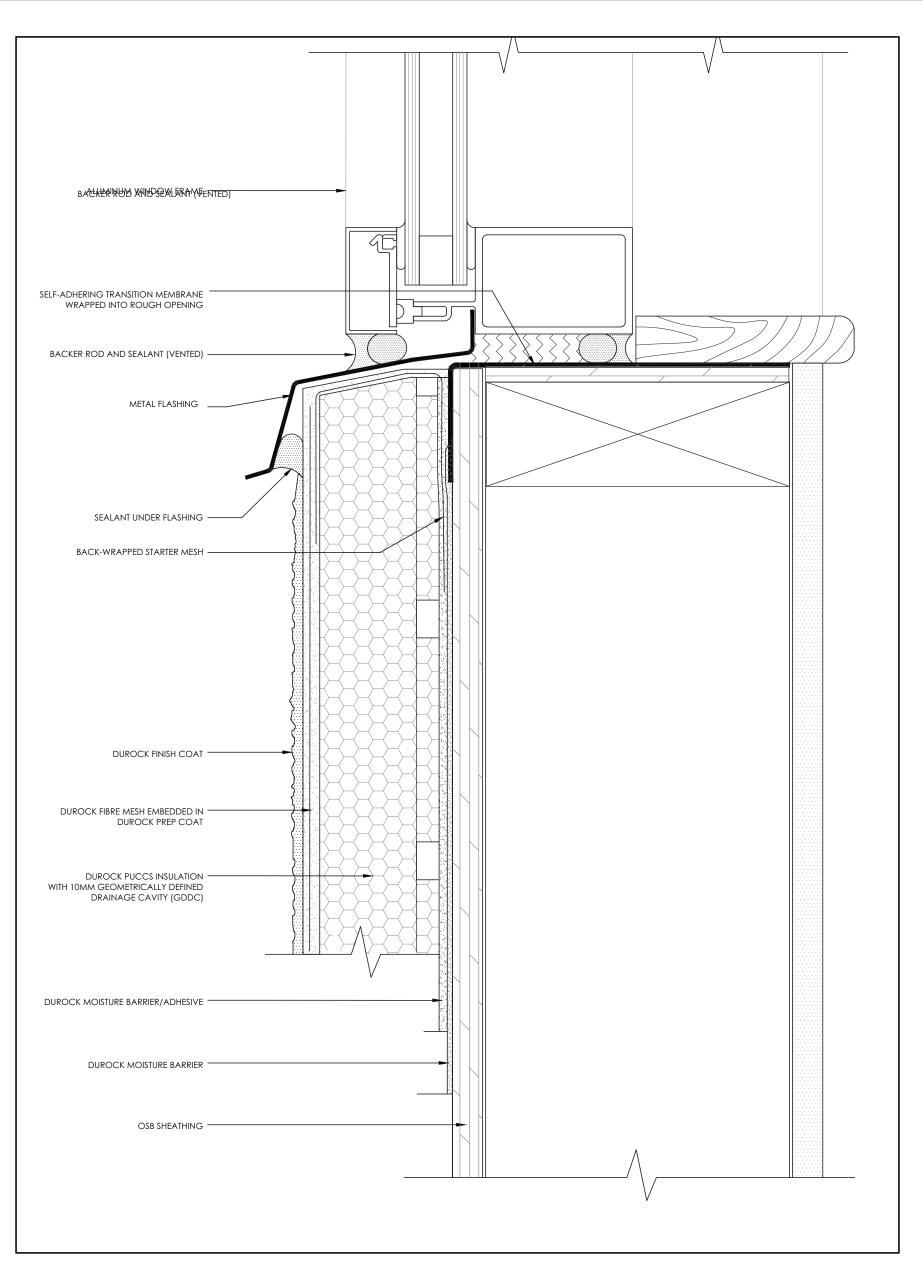



3 EIFS @ ALUMINUM WINDOW SILL DETAIL (TYP.)
A5.1 SCALE 1:2



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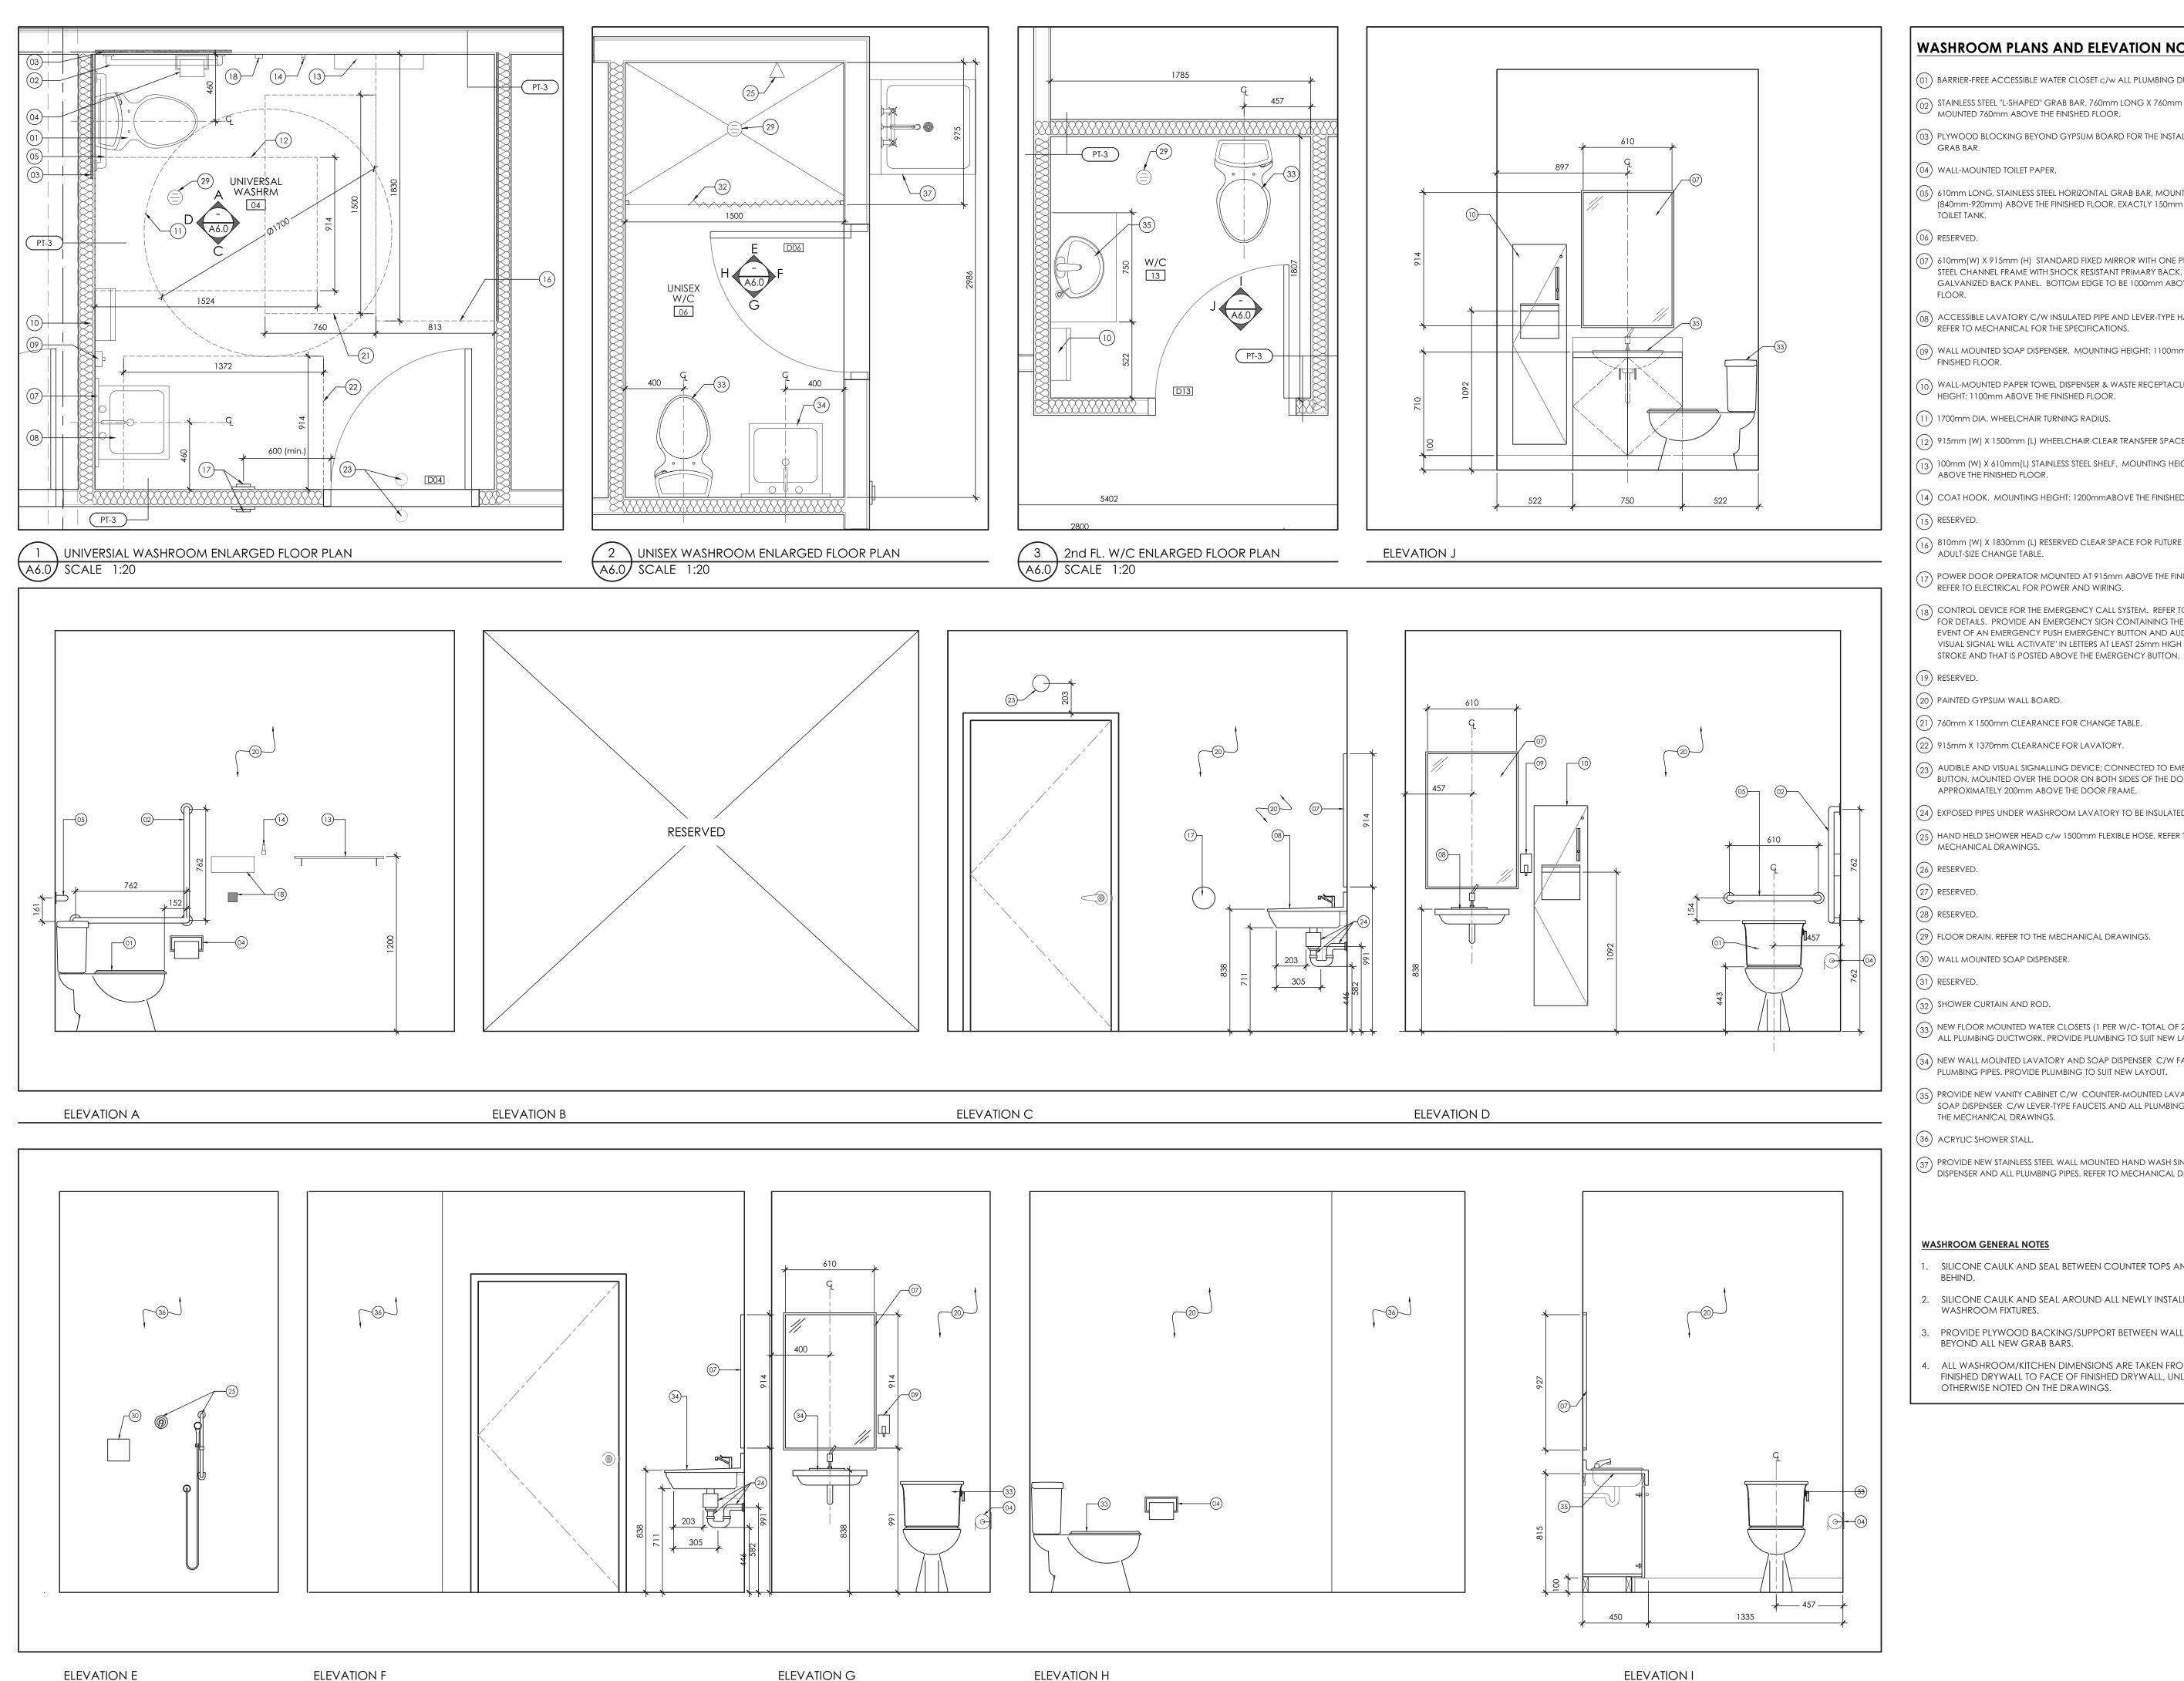
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DETAILS

C.M. | DRAWING NO. DRAWN BY A5.1 REVIEWED BY START DATE 2017/06/05 PROJECT NO. 17004 REVISION NO.

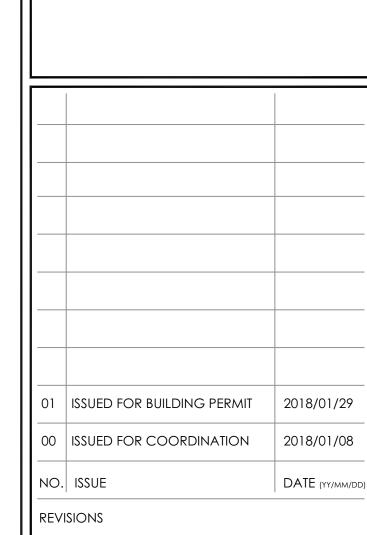

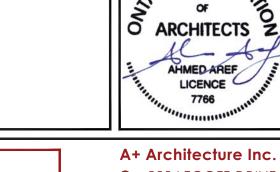WASHROOM PLANS AND ELEVATION NOTES


- 01) BARRIER-FREE ACCESSIBLE WATER CLOSET C/W ALL PLUMBING DUCTWORK.
- STAINLESS STEEL "L-SHAPED" GRAB BAR, 760mm LONG X 760mm HIGH,
- MOUNTED 760mm ABOVE THE FINISHED FLOOR.
- (03) PLYWOOD BLOCKING BEYOND GYPSUM BOARD FOR THE INSTALLATION OF
- (04) WALL-MOUNTED TOILET PAPER.
- (05) 610mm LONG, STAINLESS STEEL HORIZONTAL GRAB BAR, MOUNTED (840mm-920mm) ABOVE THE FINISHED FLOOR, EXACTLY 150mm ABOVE THE
- (07) 610mm(W) X 915mm (H) STANDARD FIXED MIRROR WITH ONE PIECE STAINLESS STEEL CHANNEL FRAME WITH SHOCK RESISTANT PRIMARY BACK, PROVIDE FULL GALVANIZED BACK PANEL. BOTTOM EDGE TO BE 1000mm ABOVE THE FINISHED
- $\binom{1}{08}$ ACCESSIBLE LAVATORY C/W INSULATED PIPE AND LEVER-TYPE HANDLE FAUCET. REFER TO MECHANICAL FOR THE SPECIFICATIONS.
- (09) WALL MOUNTED SOAP DISPENSER. MOUNTING HEIGHT: 1100mm ABOVE THE FINISHED FLOOR.
- (10) WALL-MOUNTED PAPER TOWEL DISPENSER & WASTE RECEPTACLE. DISPENSING HEIGHT: 1100mm ABOVE THE FINISHED FLOOR.
- (11) 1700mm DIA. WHEELCHAIR TURNING RADIUS.
- (12) 915mm (W) X 1500mm (L) WHEELCHAIR CLEAR TRANSFER SPACE.
- (13) 100mm (W) X 610mm(L) STAINLESS STEEL SHELF. MOUNTING HEIGHT: 1200mm ABOVE THE FINISHED FLOOR.
- (14) COAT HOOK. MOUNTING HEIGHT: 1200mmABOVE THE FINISHED FLOOR.
- 810mm (W) X 1830mm (L) RESERVED CLEAR SPACE FOR FUTURE LOCATION OF
- POWER DOOR OPERATOR MOUNTED AT 915mm ABOVE THE FINISHED FLOOR.
- CONTROL DEVICE FOR THE EMERGENCY CALL SYSTEM. REFER TO ELECTRICAL FOR DETAILS. PROVIDE AN EMERGENCY SIGN CONTAINING THE WORDS "IN THE EVENT OF AN EMERGENCY PUSH EMERGENCY BUTTON AND AUDIBLE AND VISUAL SIGNAL WILL ACTIVATE" IN LETTERS AT LEAST 25mm HIGH WITH 6mm
- (21) 760mm X 1500mm CLEARANCE FOR CHANGE TABLE.
- (22) 915mm X 1370mm CLEARANCE FOR LAVATORY.
- 23) AUDIBLE AND VISUAL SIGNALLING DEVICE; CONNECTED TO EMERGENCY CALL BUTTON, MOUNTED OVER THE DOOR ON BOTH SIDES OF THE DOOR, APPROXIMATELY 200mm ABOVE THE DOOR FRAME.
- (24) EXPOSED PIPES UNDER WASHROOM LAVATORY TO BE INSULATED.
- HAND HELD SHOWER HEAD C/W 1500mm FLEXIBLE HOSE. REFER TO THE MECHANICAL DRAWINGS.
- (29) FLOOR DRAIN. REFER TO THE MECHANICAL DRAWINGS.
- (30) WALL MOUNTED SOAP DISPENSER.
- 32) SHOWER CURTAIN AND ROD.
- NEW FLOOR MOUNTED WATER CLOSETS (1 PER W/C- TOTAL OF 2 UNITS) C/W ALL PLUMBING DUCTWORK. PROVIDE PLUMBING TO SUIT NEW LAYOUT.
- 34) NEW WALL MOUNTED LAVATORY AND SOAP DISPENSER C/W FAUCETS AND ALL PLUMBING PIPES. PROVIDE PLUMBING TO SUIT NEW LAYOUT.
- PROVIDE NEW VANITY CABINET C/W COUNTER-MOUNTED LAVATORY AND
- SOAP DISPENSER C/W LEVER-TYPE FAUCETS AND ALL PLUMBING PIPES. REFER TO THE MECHANICAL DRAWINGS.
- 36) ACRYLIC SHOWER STALL.
- PROVIDE NEW STAINLESS STEEL WALL MOUNTED HAND WASH SINK C/W SOAP DISPENSER AND ALL PLUMBING PIPES. REFER TO MECHANICAL DRAWINGS.


- SILICONE CAULK AND SEAL BETWEEN COUNTER TOPS AND WALL
- 2. SILICONE CAULK AND SEAL AROUND ALL NEWLY INSTALLED WASHROOM FIXTURES.
- PROVIDE PLYWOOD BACKING/SUPPORT BETWEEN WALL STUDS
- ALL WASHROOM/KITCHEN DIMENSIONS ARE TAKEN FROM FACE OF FINISHED DRYWALL TO FACE OF FINISHED DRYWALL, UNLESS OTHERWISE NOTED ON THE DRAWINGS.



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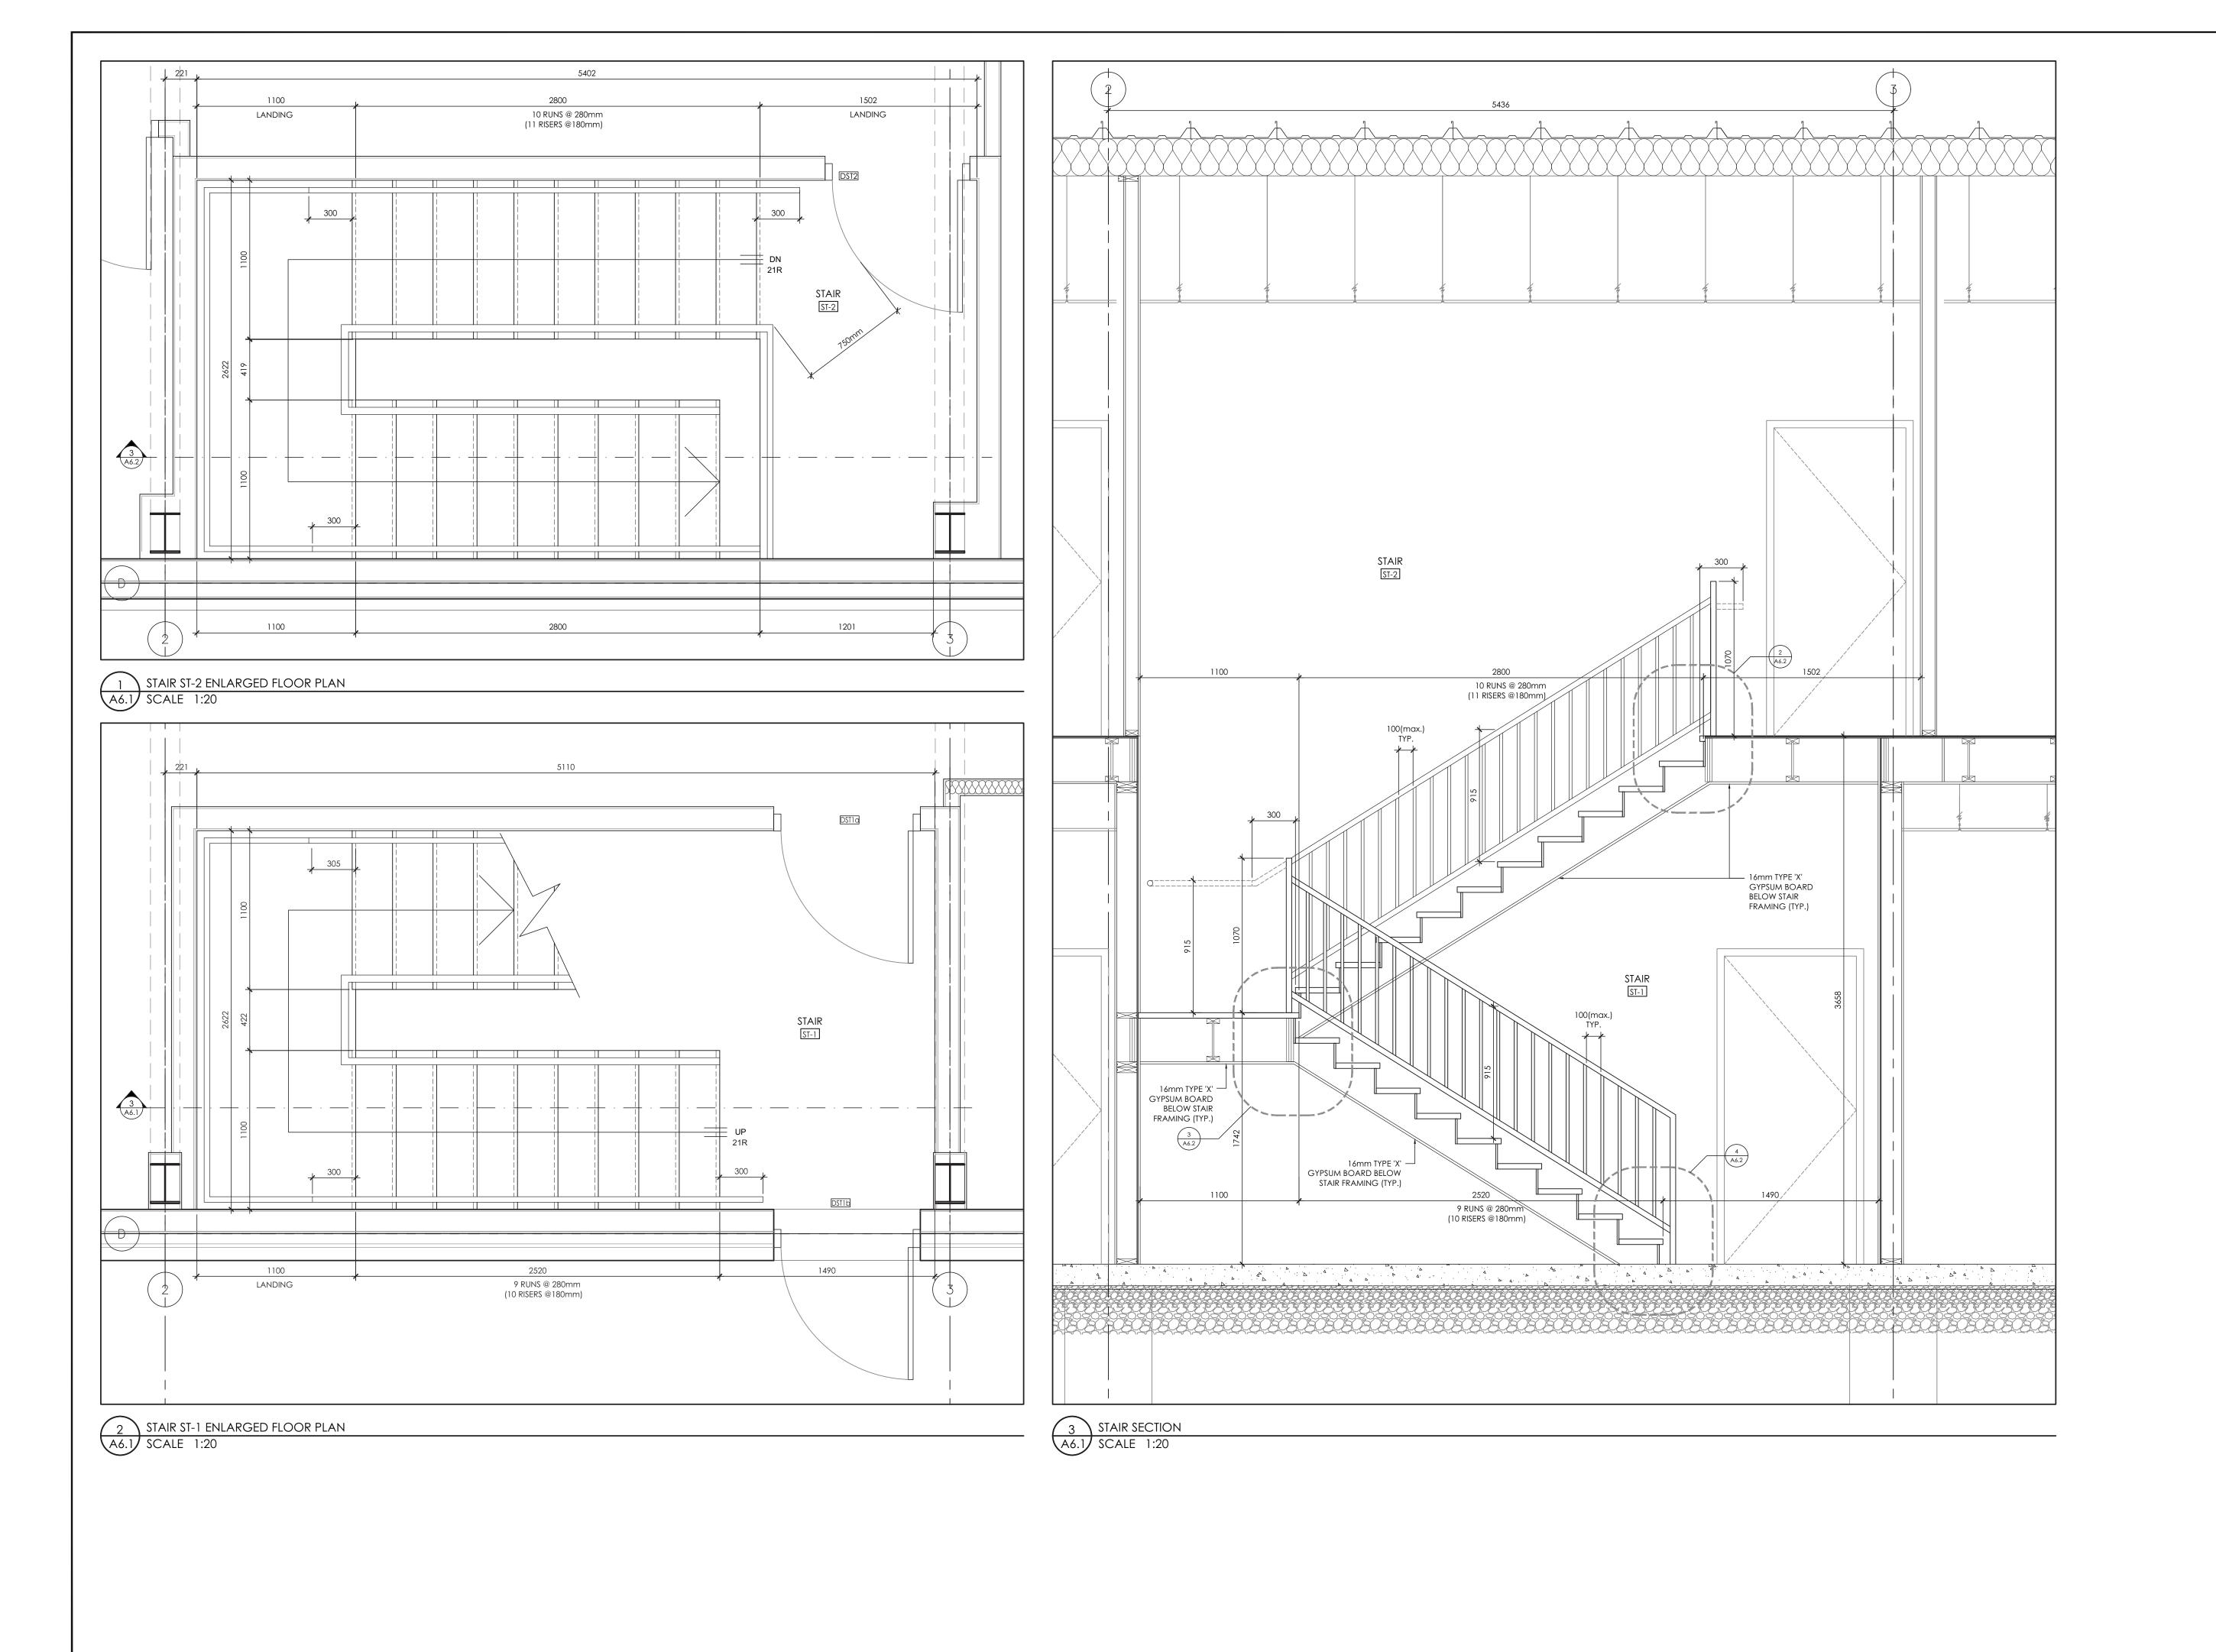
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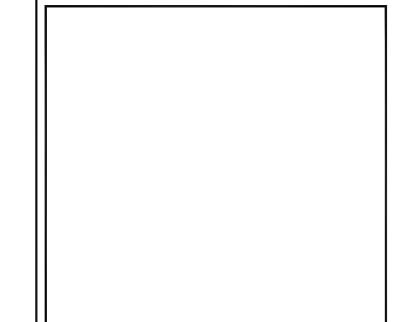
WASHROOM ENLARGED PLANS, ELEVATIONS AND **DETAILS**


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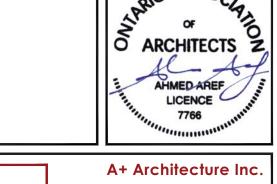


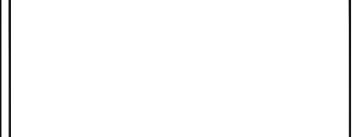
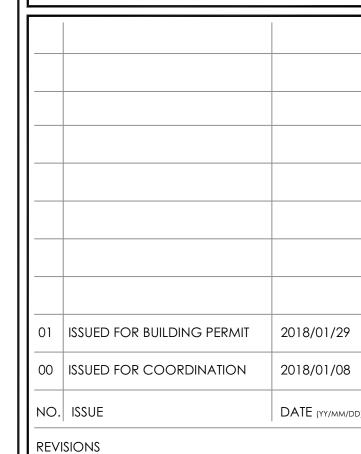
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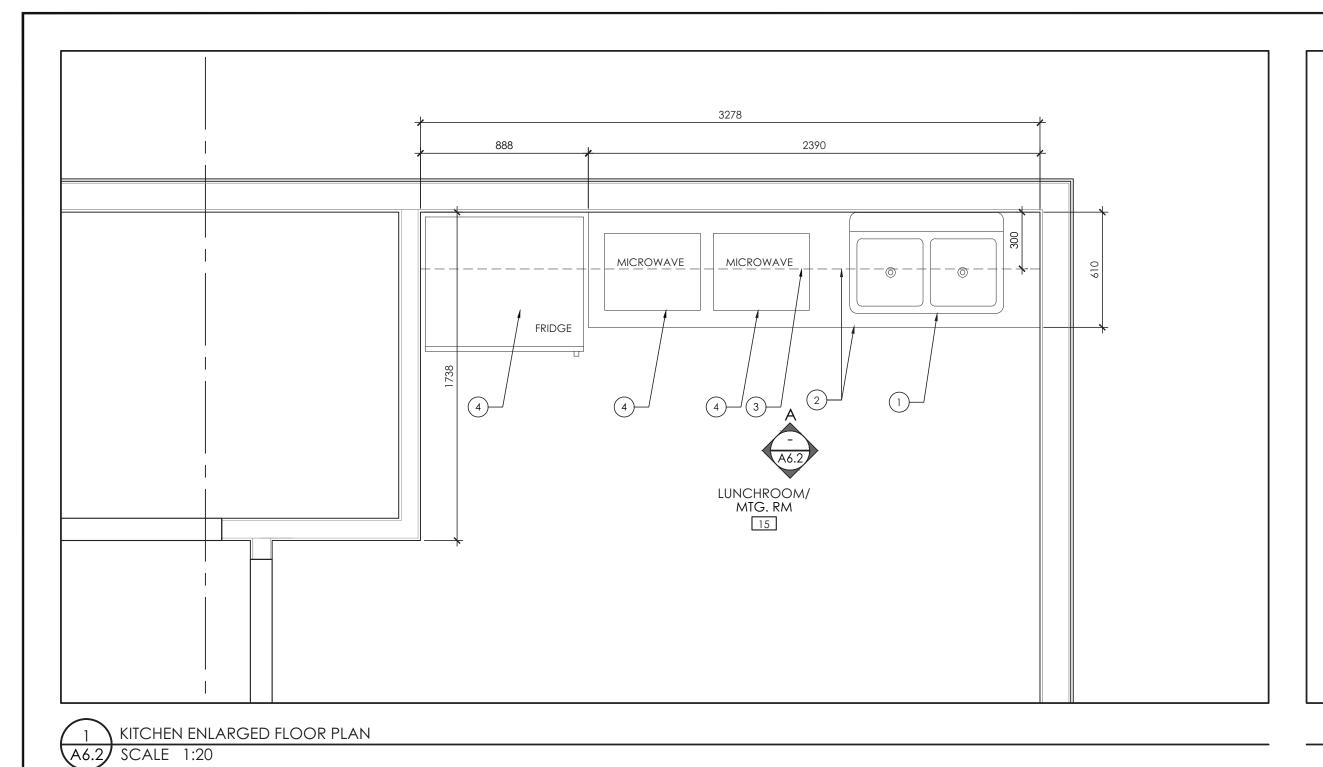
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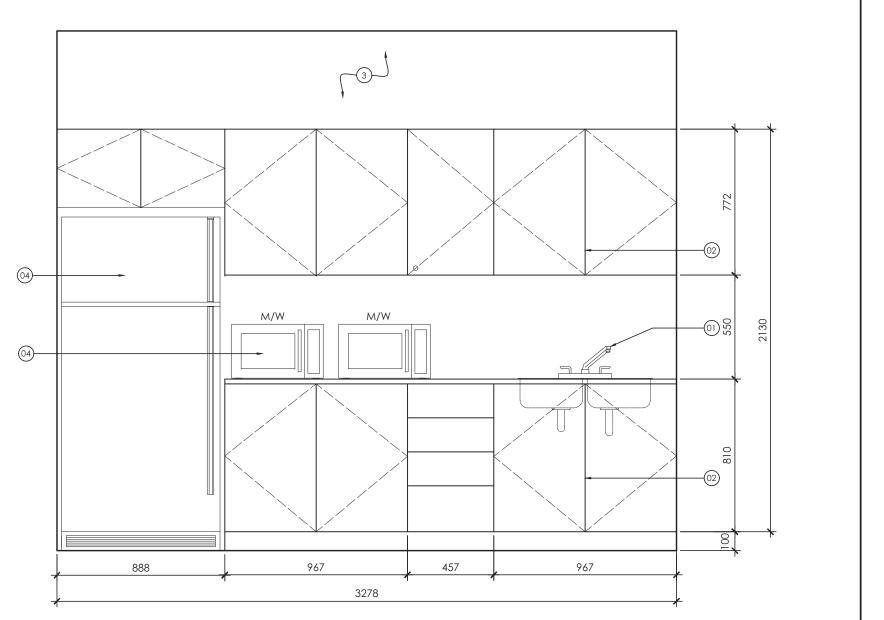
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STAIR ENLARGED PLANS AND SECTION

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KITCHEN PLANS AND ELEVATION NOTES


- (01) PROVIDE NEW STAINLESS STEEL KITCHEN SINK C/W LEVER-TYPE FAUCETS AND ALI PLUMBING PIPES. REFER TO THE MECHANICAL DRAWINGS.
- COUNTERTOP, UPPER AND LOWER CABINETS CONSTRUCTION: P-LAM FINISH ON 19mm PLYWOOD. ALL CONCEALED SURFACES TO RECEIVE WHITE MELAMINE FINISH. ALL EXPOSED SURFACES AND EDGES TO HAVE PRE LAMINATED FINISH. COLOUR TO BE
- (03) LINE OF UPPER CABINETS ABOVE.

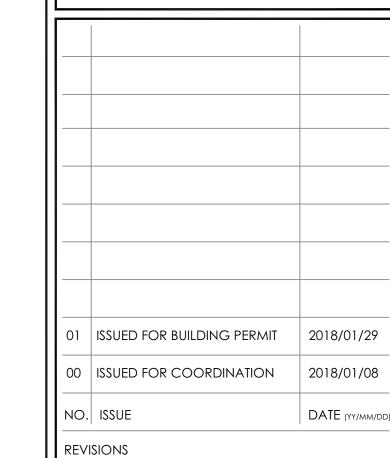SELECTED BY OWNER.

- (04) APPLIANCES BY OWNER.
- (05) RESERVED

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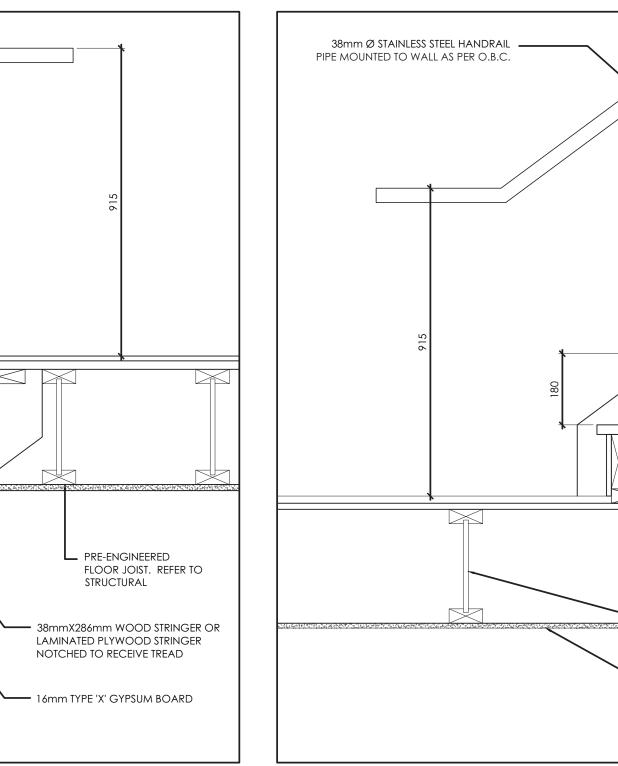
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AND ELEVATION, TYPICAL STAIR DETAILS

KITCHEN ENLARGED PLAN

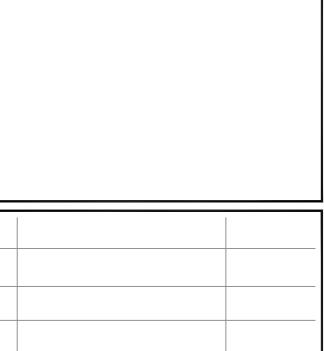
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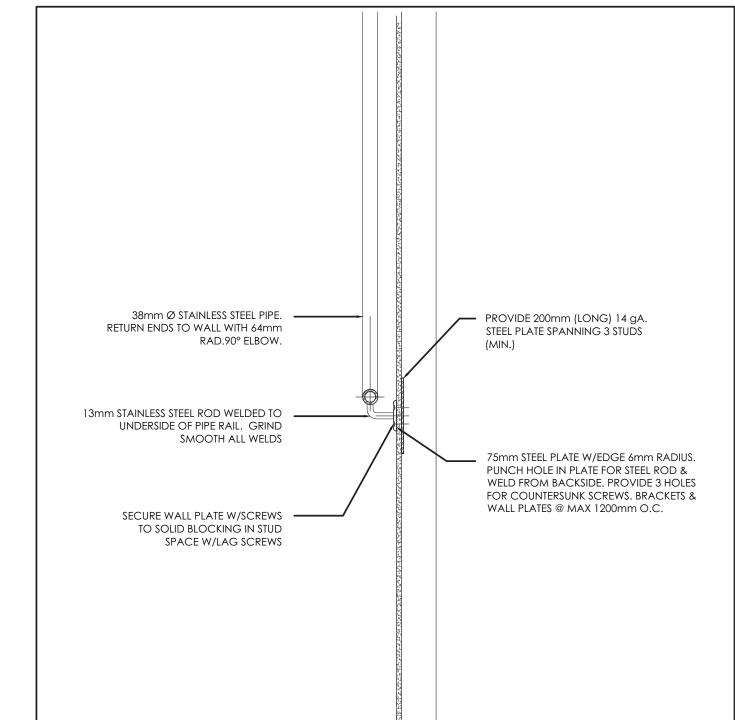
ELEVATION A



13mm WOOD RISER — 38mm WOOD TREAD — - 38mmX286mm WOOD STRINGER OR LAMINATED
PLYWOOD STRINGER NOTCHED TO RECEIVE TREAD WOOD BLOCKING AS REQUIRED PRE-ENGINEERED
FLOOR JOIST/LVL HEADER,
REFER TO STRUCTURAL 16mm TYPE 'X' GYPSUM BOARD 3 STAIR DETAIL A6.2 SCALE 1:10





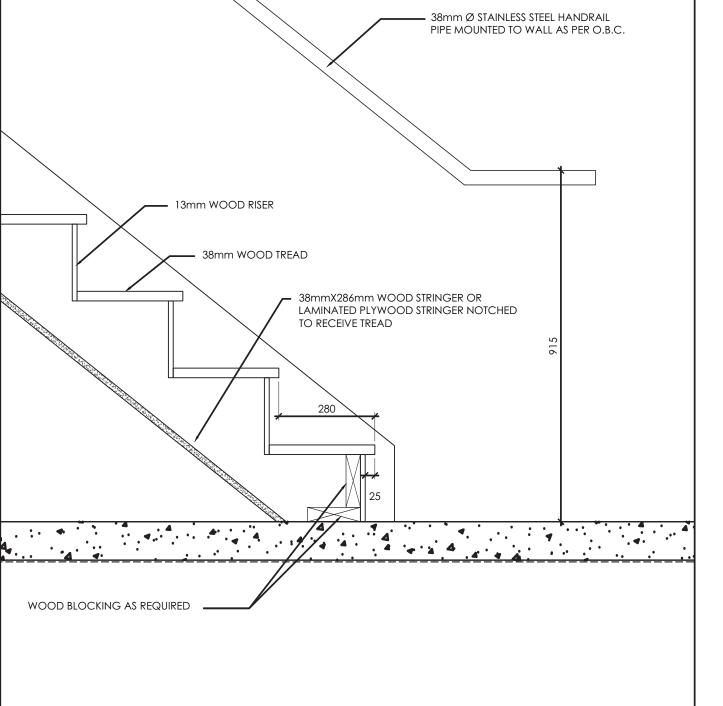

5 HANDRAIL WALL ATTACHMENT DETAIL (TYP.)
A6.2 SCALE 1:10

2 STAIR TREAD/RISER TYPICAL DETAIL
A6.2 SCALE 1:10

38mm Ø STAINLESS STEEL HANDRAIL ____


25mm WOOD NOSING

13mm WOOD RISER —

38mm WOOD TREAD —

PIPE MOUNTED TO WALL AS PER O.B.C.

PRE-ENGINEERED

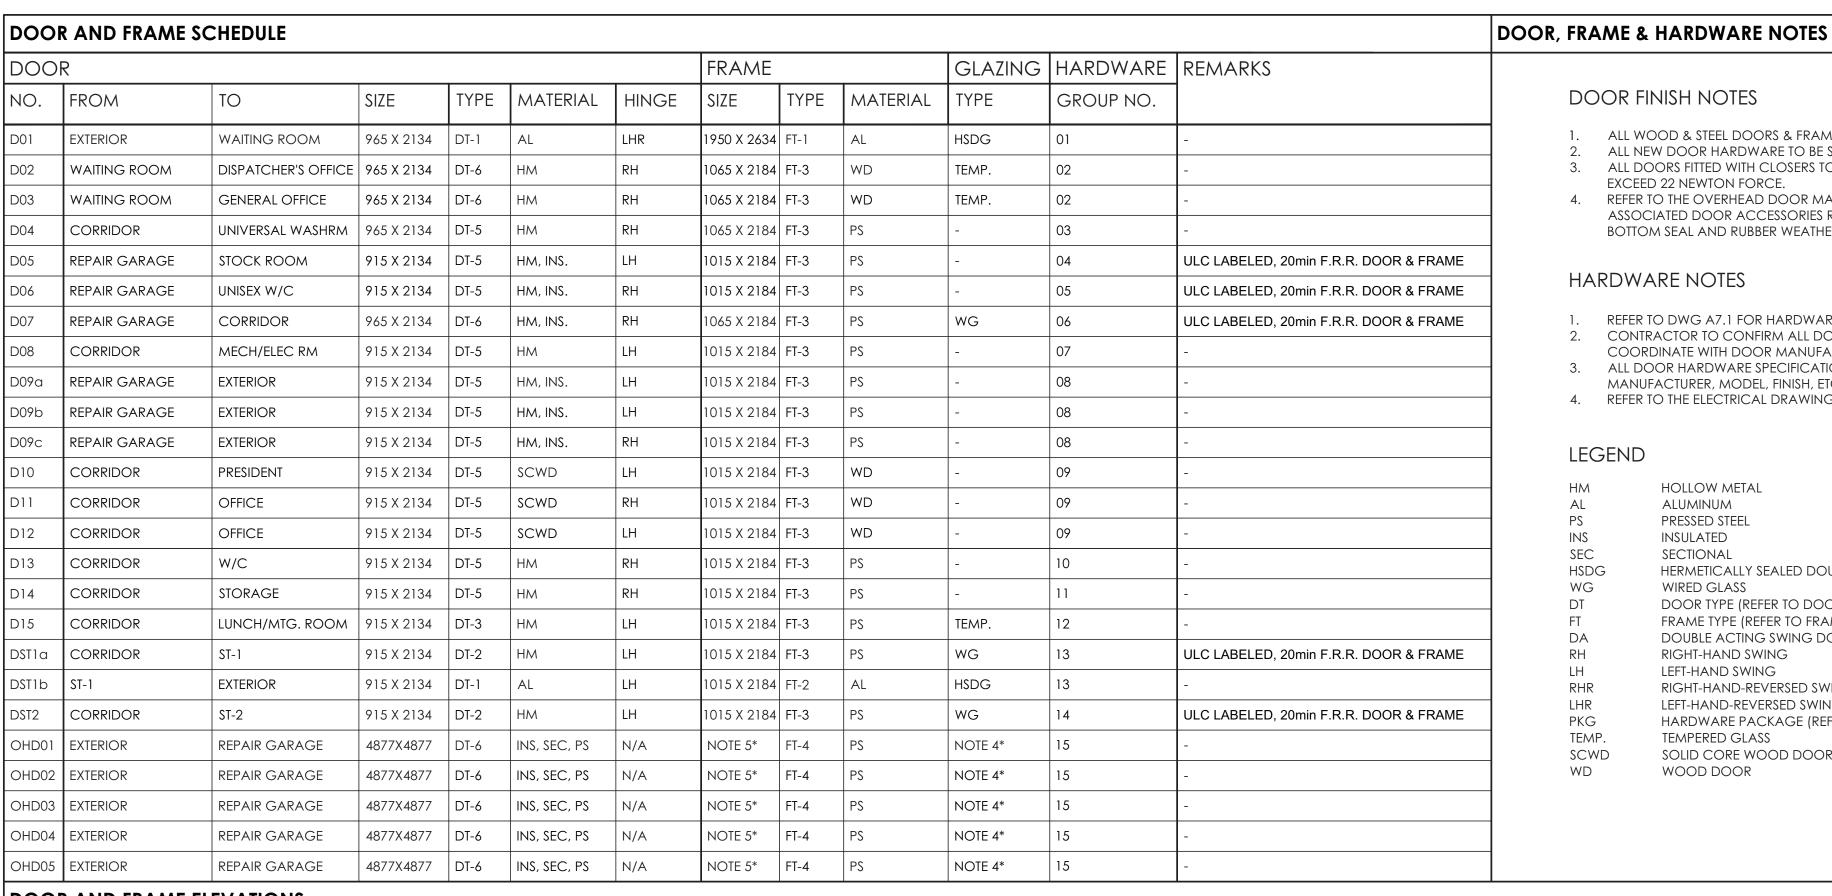

DOOR FINISH NOTES

- ALL WOOD & STEEL DOORS & FRAMES TO BE PAINTED, COLOUR TO BE SELECTED BY THE OWNER.
 - ALL NEW DOOR HARDWARE TO BE SELECTED BY THE OWNER FOR STYLE, FINISH, AND INSTALLATION. ALL DOORS FITTED WITH CLOSERS TO BE ADJUSTED SO THAT THE FORCE REQUIRED TO OPEN THE DOOR DOES NOT
- EXCEED 22 NEWTON FORCE.
- REFER TO THE OVERHEAD DOOR MANUFACTURER FOR FRAME SIZE, STEEL GAUGE, HARDWARE, WIRING AND ALL ASSOCIATED DOOR ACCESSORIES REQUIRED TO OPERATE THE DOOR. OVERHEAD DOOR TO INCLUDE A WEATHER BOTTOM SEAL AND RUBBER WEATHER-STRIPPING (TYP. ALL 3 SIDES).

HARDWARE NOTES

- REFER TO DWG A7.1 FOR HARDWARE GROUPS.
- CONTRACTOR TO CONFIRM ALL DOOR LOCKSET FUNCTIONS WITH THE OWNER PRIOR TO ORDERING ALL HARDWARE.
- COORDINATE WITH DOOR MANUFACTURER/SUPPLIER.
- ALL DOOR HARDWARE SPECIFICATIONS TO BE COORDINATED WITH, AND CONFIRMED BY, THE OWNER FOR
- MANUFACTURER, MODEL, FINISH, ETC.
- 4. REFER TO THE ELECTRICAL DRAWINGS FOR CONDUITS, WIRING, FIRE-ALARM CONNECTIONS, ETC.

LEGEND

HOLLOW METAL ALUMINUM PRESSED STEEL INS INSULATED

SEC SECTIONAL

HSDG HERMETICALLY SEALED DOUBLE GLAZING WG WIRED GLASS DOOR TYPE (REFER TO DOOR ELEVATION) FRAME TYPE (REFER TO FRAME ELEVATION)

DA DOUBLE ACTING SWING DOOR RH RIGHT-HAND SWING LEFT-HAND SWING

RIGHT-HAND-REVERSED SWING RHR LEFT-HAND-REVERSED SWING LHR


PKG HARDWARE PACKAGE (REFER TO THE HARDWARE SCHEDULE)

TEMP. TEMPERED GLASS


SCWD SOLID CORE WOOD DOOR

WOOD DOOR

DOOR AND FRAME ELEVATIONS (SCALE 1:50)

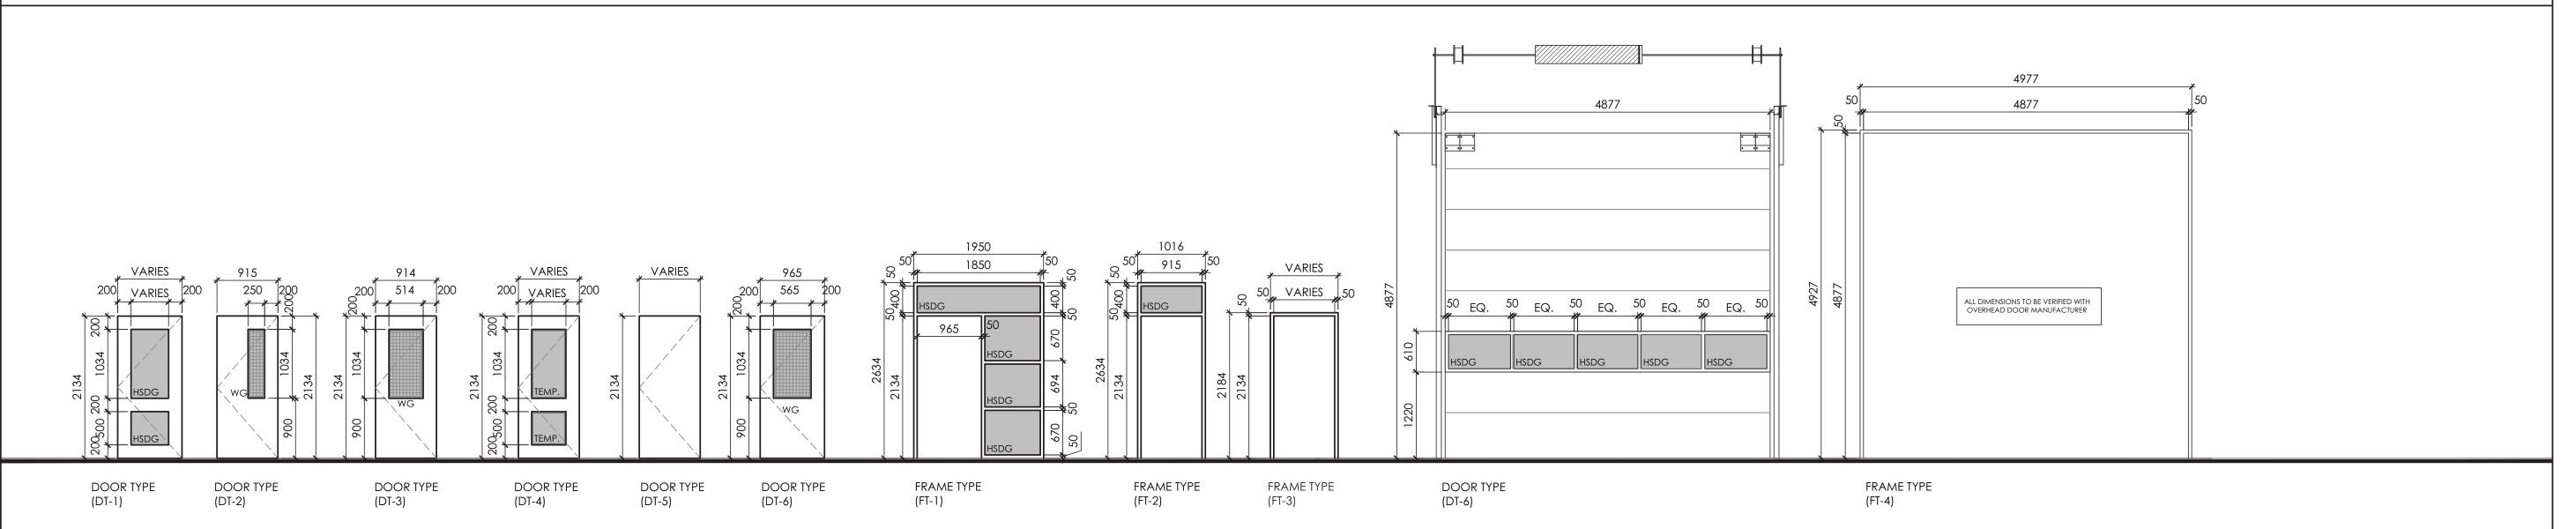

WINDOW ELEVATIONS (SCALE 1:50)

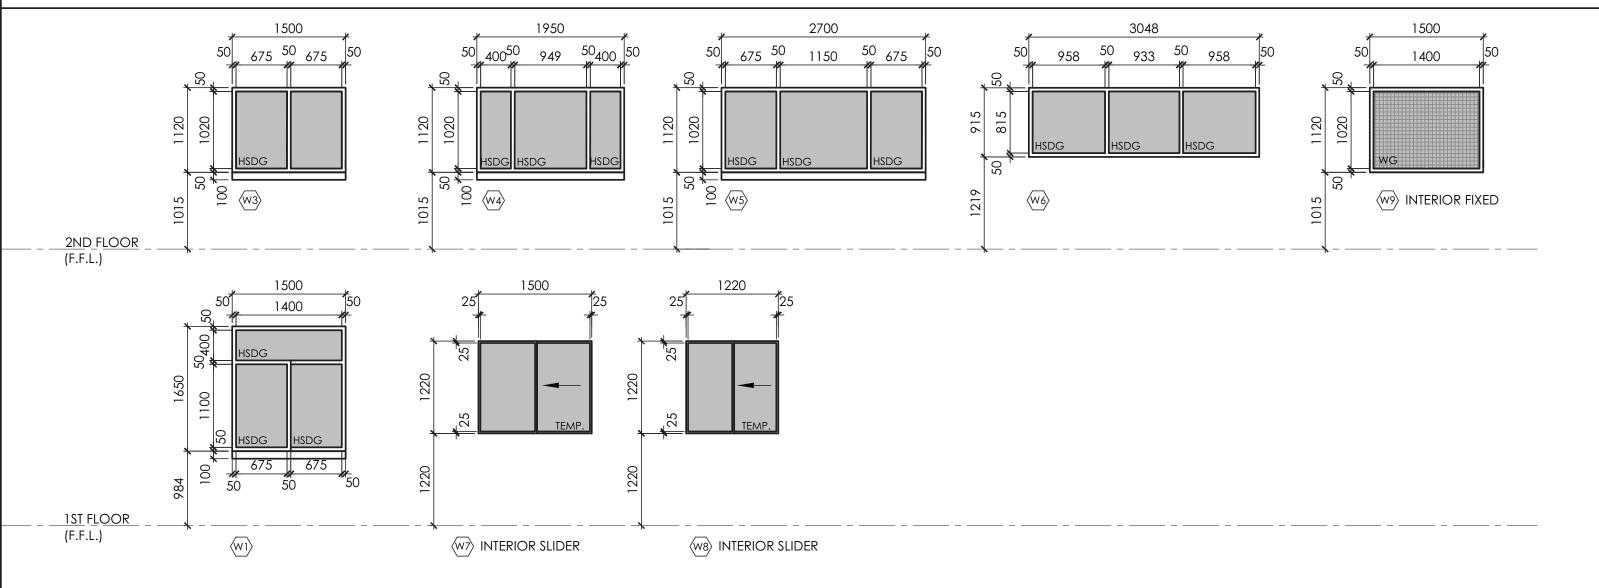




GENERAL NOTES

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NO.	ISSUE	DATE (YY/MM/D			
REVISIONS					

ORIENTATION



A+ Architecture Inc

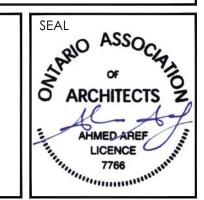Kanata, ON K2K 2X3





BRY-AIN HOLDINGS LTD.

PROJECT

EQUIPMENT REPAIR GARAGE

2688 CARP ROAD KANATA, ON KOA 1LO

DRAWING TITLE

SCHEDULES

DRAWN BY	C.M.	DRAWING NO.
REVIEWED BY	A.A.	Λ'
START DATE 20	17/06/05	

PROJECT NO. 17004 REVISION NO.

OOR	HARDWARE SCHEDUI	LE							
IARDWA	ARE GROUP NO. 01 - D01				HARDWARE	GROUP NO. 08 - D09c	ı, D09b, D09c		
Qty 1 EA	DEADLOCK MORTISE THUMBTURN MORTISE CYLINDER PUSH/PULL BAR OH STOP SURF. AUTO OPERATOR WEATHER RING	Catalog Number 112XY TD1850 TT1025 20-013 118 9190HD-305MM-NS 100S ADJ 9542 MS	Finish 628 626 630 630 ANCLR PLA	Mfr IVE TAH TAH SCH IVE GLY LCN	Qty 3 EA 1	Description HINGE PANIC HARDWARE SURFACE CLOSER PROTECTION PLATE GASKETING DOOR SWEEP THRESHOLD MOUNTING BRACKET DOOR CONTACT	Catalog Number 5BB1 114X102MM NRP 25-R-EO 4050 SHCUSH 8400 215MM X 40MM LDW B-CS 328AA-S (1XDR W, 2 X DR H) 39A X DR W 655A-223 X OPENING W 328SPB 679-05HM	Finish 630 626 689 612 AA A BLK	Mfr IVE FAL LCN IVE ZER ZER ZER ZER SCE
1 EA 2 EA 2 EA	A ACTUATOR, WALL MOUNT	8310-806K 8310-852 8310-876	BLK 630 689	LCN LCN LCN	HARDWARE	GROUP NO. 09 - D10,	D11, D12		
1 EA 1 SE 1 EA 1 EA	MOUNTING PLATE ET WEATHERSTRIP A DOOR SWEEP A THRESHOLD	9540-18 WEATHERSTRIP BY DOOR/FRAME MANUFACTURER 39A X DR W 655A-223 X OPENING W 679-05HM	689 A A BLK	LCN UNK ZER ZER SCE		Description HINGE ENTRY / OFFICE LOCK PROTECTION PLATE WALL STOP	Catalog Number 5BB1 114X102MM W511CP6 DANE 8400 215MM X 40MM LDW B-CS WS406/407CCV	Finish 652 626 612 626	Mfr IVE FAL IVE IVE
	ARE GROUP NO. 02 - D02,			332	HARDWARE	GROUP NO. 10 - D13			
Qty 3 EA 1 EA 1 EA	A ENTRY / OFFICE LOCK A PROTECTION PLATE	Catalog Number 5BB1 127X114MM W511CP6 DANE 8400 215MM X 40MM LDW B-CS WS406/407CCV	Finish 652 626 612 626	Mfr IVE FAL IVE IVE	Qty 3 EA 1 EA 1 EA 1 EA 1 EA	Description HINGE PRIVACY LOCK PROTECTION PLATE WALL STOP GROUP NO. 11 - D14	Catalog Number 5BB1 114X102MM W301S DANE 8400 215MM X 40MM LDW B-CS WS406/407CCV	Finish 652 626 612 626	Mfr IVE FAL IVE IVE
IARDW/	ARE GROUP NO. 03 - D04				Qty	Description	Catalog Number	Finish	Mfr
Qty 3 EA 1 EA 1 EA	A STOREROOM LOCK A ELECTRIC STRIKE	Catalog Number 5BB1HW 127X114MM W581CP6 DANE 6211 FS CON	Finish 652 626 630	Mfr IVE FAL VON	3 EA 1 EA 1 EA 1 EA	HINGE PRIVACY LOCK PROTECTION PLATE WALL STOP	5BB1 114X102MM W301S DANE 8400 215MM X 40MM LDW B-CS WS406/407CCV	652 626 612 626	IVE FAL IVE IVE
1 EA	OPERATOR ILLUMINATED	9542 MS CM-46/4/GRF/SFE1	ANCLR	CAM	HARDWARE	GROUP NO. 12 - D15			
1 EA 1 EA 1 EA 1 EA 1 EA	PROTECTION PLATE WIRE HARNESS A AURA PUSH TO LOCK DOOR CONTACT A ADVANCED LOGIC	9540-18 8400 215MM X 40MM LDW B-CS CON-6W CM-46/8/GRF/SFE1 679-05HM CX-33	689 612 BLK	LCN IVE SCH CAM SCE CAM	Qty 3 EA 1 EA 1 EA 1 EA 1 EA	Description HINGE STOREROOM LOCK SURFACE CLOSER PROTECTION PLATE WALL STOP	Catalog Number 5BB1HW 114X102MM W581CP6 DANE 1450 DEL REG 8400 215MM X 40MM LDW B-CS WS406/407CVX	Finish 652 626 689 612 626	Mfr IVE FAL LCN IVE IVE
1 EA		CX-WEC10K2 PS902 900-8F	LGR	CAM SCE	HARDWARE	GROUP NO. 13 - DST1	a, DST2		
	Description A HINGE A CLASSROOM LOCK A SURFACE CLOSER A PROTECTION PLATE A WALL STOP	Catalog Number 5BB1HW 114X102MM W561CP6 DANE 1450 DEL REG 8400 215MM X 40MM LDW B-CS WS406/407CVX 188SBK PSA (1XDR W, 2 X DR H)	Finish 652 626 689 612 626 BK	Mfr IVE FAL LCN IVE IVE ZER	Qty 3 EA 1 EA THARDWARE	Description HINGE FIRE EXIT HARDWARE SURFACE CLOSER PROTECTION PLATE WALL STOP GASKETING GROUP NO. 14 - DST1 Description	Catalog Number 5BB1HW 114X102MM F-25-R-L-BE-DANE 4050 REG 8400 215MM X 40MM LDW B-CS WS406/407CVX 188SBK PSA (1XDR W, 2 X DR H) Catalog Number	Finish 652 626 689 612 626 BK	Mfr IVE FAL LCN IVE IVE ZER
HARDWA	ARE GROUP NO. 05 - D06				1 EA 1 EA	CONT. HINGE PANIC HARDWARE	112XY 24-R-EO	628 626	IVE FAL
Qty 3 EA 1 EA	A PUBLIC RESTRM W/OCCUPANCY	Catalog Number 5BB1HW 114X102MM H2171 DANE	Finish 630 626	Mfr IVE FAL	1 EA 1 EA 1 EA 1 SET	OH STOP SURFACE CLOSER MOUNTING PLATE WEATHERSTRIP	100S 4021 4020-18G WEATHERSTRIP BY DOOR/FRAME MANUFACTURER	630 689 689	GLY LCN LCN UNK
1 EA 1 EA 1 EA	A SURFACE CLOSER A MOUNTING PLATE	100S 1450 DEL REG SRI ST-5011 1450-18 SRI 8400 215MM X 40MM LDW B-CS	630 689 689 612	GLY LCN LCN IVE	1 EA 1 EA 1 EA	DOOR SWEEP THRESHOLD DOOR CONTACT	39A X DR W 655A-223 X OPENING W 679-05HM	A A BLK	ZER ZER SCE
1 EA	A GASKETING	188SBK PSA (1XDR W, 2 X DR H)	BK	ZER			01, OHD02, OHD03, OHD04, OHD05		
ARDWA Qty	ARE GROUP NO. 06 - D07 Description	Catalog Number	Finish	Mfr	Qty 1	Description HARDWARE	Catalog Number BY DOOR & FRAME MANUFACTURER	Finish	Mfr UNK
3 EA 1 EA 1 EA	A HINGÉ A CLASSROOM LOCK A SURFACE CLOSER	5BB1HW 127X114MM NRP W561CP6 DANE 4050 DEL REG 9542 MS	652 626 689 ANCLR	IVE FAL LCN LCN					
1 SE 1 EA 1 EA 1 EA	T WEATHERSTRIP A PROTECTION PLATE A WALL STOP	WEATHERSTRIP BY DOOR/FRAME MANUFACTURER 8400 215MM X 40MM LDW B-CS WS406/407CVX 188SBK PSA (1XDR W, 2 X DR H)	612 626 BK	UNK IVE IVE ZER					
HARDW <i>A</i>	ARE GROUP NO. 07 - D08								
Qty 3 EA 1 EA 1 EA	STOREROOM LOCK	Catalog Number 5BB1 114X102MM W581CP6 DANE 8400 215MM X 40MM LDW B-CS WS406/407CVX	Finish 652 626 612 626	Mfr IVE FAL IVE IVE					



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ORIENTATION



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A+ Architecture Inc.

ARCHITECTS Z

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BRY-AIN HOLDINGS LTD.

EQUIPMENT REPAIR GARAGE

2688 CARP ROAD KANATA, ON KOA 1LO

DRAWING TITLE

DOOR HARDWARE **SCHEDULES**

DRAWN BY C.M. | DRAWING NO. REVIEWED BY A.A. A7.1 START DATE 2017/06/05 PROJECT NO. 17004 REVISION NO. 01